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#### DESCRIPTION TITLE SHEET **GENERAL NOTES** SURVEY CONTROL PLAN **EXISTING SITE PLAN** PROJECT LAYOUT ENLARGED PARTIAL PLAN I **ENLARGED PARTIAL PLAN II ENLARGED PARTIAL PLAN III ENLARGED PARTIAL PLAN IV** 10 ENLARGED PARTIAL PLAN V 11 SECTIONS AND DETAILS I 12 SECTIONS AND DETAILS II 13 SECTIONS AND DETAILS III SECTIONS AND DETAILS IV 15 MISCELLANEOUS DETAILS 16 LOCATION POINT TABLES 17 **CROSS SECTIONS I** 18 CROSS SECTIONS II

CROSS SECTIONS III

**CROSS SECTIONS IV** 

CROSS SECTIONS V


**CROSS SECTIONS VI** 


**CROSS SECTIONS VII** 

## STATE OF LOUISIANA COASTAL PROTECTION AND RESTORATION AUTHORITY

# ROCKEFELLER REFUGE GULF SHORELINE STABILIZATION PROJECT

## ME-18 CAMERON PARISH, LOUISIANA

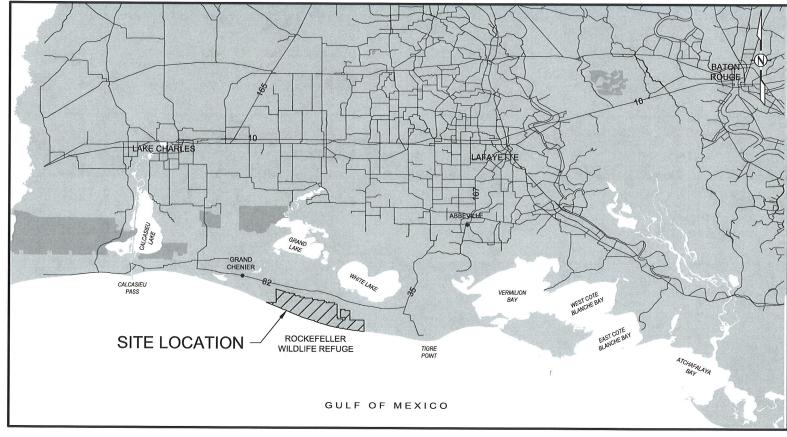

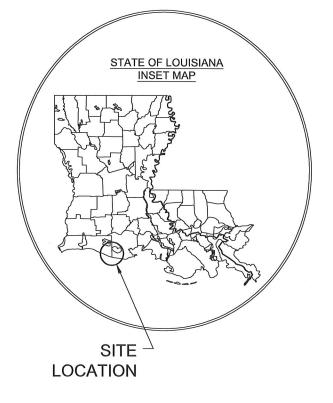

CHIEF, ENGINEERING DIVISION

ENGINEER MANAGER

ENGINEER SUPERVISOR

PROJECT ENGINEER INTERN









#### LICENSURE CLASSIFICATION REQUIREMENTS


CALL BEFORE YOU DIG!

1-800-272-3020

LOUISIANA ONE CALL PARTICIPANTS REQUEST
48 HOURS NOTICE BEFORE YOU DIG,
DRILL, OR BLAST - STOP CALL

LOUISIANA ONE CAll System

MAJOR CLASSIFICATION: HEAVY CONSTRUCTION

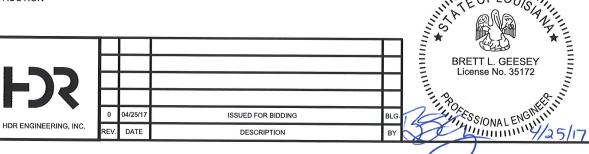

## COASTAL PROTECTION & RESTORATION AUTHORITY ENGINEERING DIVISION

150 TERRACE AVENUE BATON ROUGE, LOUISIANA 70802

DRAWN BY: E. CONTRERAS DESIGNED BY: ERIN ROONEY, P.E.

ROCKEFELLER REFUGE GULF
SHORELINE STABILIZATION PROJECT

TITLE SHEET

STATE PROJECT NUMBER: ME-18

FEDERAL PROJECT NUMBER: ME-18

DATE: APRIL 2017

APPROVED BY: BRETT L. GEESEY, P.E. SHEET 1 OF 23

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#### **GENERAL NOTES:**

- CONTRACTOR SHALL ACCESS PROJECT SITE FROM A NAVIGABLE WATER BODY. DREDGING FOR SITE ACCESS SHALL ONLY BE PERFORMED WITHIN THE LIMITS SHOWN FOR TEMPORARY FLOTATION CHANNELS.
- 2. CONTRACTOR SHALL PERFORM A HAZARD SURVEY AND LOCATE ALL UTILITIES AND OBSTRUCTIONS PRIOR TO COMMENCING WORK (REFER TO SHEET 4, "EXISTING SITE PLAN"). ALL PIPELINES AND UNDERGROUND UTILITIES SHALL BE MARKED WITH BUOYS BY CONTRACTOR. CONTRACTOR SHALL MAINTAIN BUOYS DURING CONSTRUCTION. CONTRACTOR SHALL NOT ANCHOR, SPUD, OR EXCAVATE WITHIN 100 FEET OF ANY PIPELINE. CONTRACTOR SHALL CONTACT LOUISIANA ONE CALL AT 1-800-272-3020 AT LEAST 5 WORKING DAYS PRIOR TO START OF CONSTRUCTION.
- 3. PROJECT IS WITHIN AND ADJACENT TO ENVIRONMENTALLY-SENSITIVE AREAS. CONTRACTOR SHALL AVOID / MINIMIZE IMPACTS TO THESE AREAS DURING THE COURSE OF WORK. OWNER RESERVES THE RIGHT TO SUSPEND WORK AT ANY TIME IF IMPACTS OCCUR UNTIL SATISFACTORY CORRECTIVE MEASURES ARE IMPLEMENTED BY CONTRACTOR TO THE SATISFACTION OF REGULATORY AGENCIES AND/OR ROCKEFELLER WILDLIFE REFUGE (REFUGE).
- 4. CONTRACTOR SHALL BE FAMILIAR WITH EXISTING SOFT SOIL CONDITIONS AT THE WORK SITE. SOIL BORING LOCATIONS AND GEOTECHNICAL INFORMATION ARE PROVIDED ON SHEET 4 AND IN APPENDIX E OF THE SPECIFICATIONS. IN PREPARING BIDS, CONTRACTORS SHALL ANTICIPATE AVERAGE CONSTRUCTION SETTLEMENTS OF UP TO 2 FEET. REFER TO PLACEMENT CRITERIA ON THESE DRAWINGS AND IN THE SPECIFICATIONS.
- 5. SIGNIFICANT COASTAL EROSION AND SHORELINE RETREAT HAS OCCURRED AT THE PROJECT SITE SINCE COLLECTION OF THE TOPOGRAPHIC AND BATHYMETRIC SURVEYS SHOWN ON THESE DRAWINGS, ACTUAL LOCATION OF CONSTRUCTION BASELINE AND OFFSETS TO PROPOSED WORK WILL BE DETERMINED BY ENGINEER PRIOR TO CONSTRUCTION BASED ON RESULTS OF CONTRACTOR'S INITIAL SURVEY.
- CONTRACTOR SHALL VERIFY ALL EXISTING CONDITIONS PRIOR TO COMMENCING CONSTRUCTION ACTIVITIES. DISCREPANCIES SHALL BE IMMEDIATELY REPORTED TO ENGINEER.
- 7. THE PROJECT IS LOCATED IN THE GULF OF MEXICO WITHIN THE ROCKEFELLER WILDLIFE REFUGE AND IS MANAGED BY THE LOUISIANA DEPARTMENT OF WILDLIFE AND FISHERIES. CONTRACTOR SHALL FOLLOW ALL RULES AND REGULATIONS FOR WORKING WITHIN ROCKEFELLER WILDLIFE REFUGE. A COPY OF THE REGULATIONS, INCLUDING CONTACT INFORMATION, IS PROVIDED IN APPENDIX H.
- 8. CONTRACTOR SHALL MAKE HIS OWN ARRANGEMENTS, OBTAIN PERMISSION FROM APPLICABLE PROPERTY OWNERS, AND PAY ALL ASSOCIATED FEES FOR STAGING, FABRICATION, AND LOADING BARGES ON PRIVATE PROPERTY. ACCESS TO THE BOAT LAUNCH OFF HWY 82 FOR JOSEPH HARBOR BAYOU CROSSES PRIVATE PROPERTY. MR. RICHARD STURLESE SHALL BE CONTACTED TO DISCUSS ACCESS REQUIREMENTS, INCLUDING A POSSIBLE FEE, PRIOR TO BIDDING. MR. STURLESE CAN BE REACHED AT 337-993-0962, CELL 337-278-0119. UPON SIGNING CONSTRUCTION CONTRACT, CONTRACTOR ACCEPTS RESPONSIBILITY FOR ACQUISITION OF ALL PERMISSIONS, AUTHORIZATIONS, EASEMENTS, AND / OR ACCESS AGREEMENTS NECESSARY FOR CONSTRUCTION OF THIS PROJECT.
- WATER DEPTHS VARY AND MAY NOT ACCOMMODATE DRAFT OF FULLY-LOADED BARGES. PROVISIONS SHALL
  BE MADE TO ACCESS SHALLOWER AREAS THROUGH USE OF LIGHT-LOADED BARGES OR OTHER EQUIPMENT
  SUITED TO SHALLOWER WATER.
- 10. AT CONTRACTOR'S OPTION, TEMPORARY FLOTATION CHANNELS MAY BE MECHANICALLY DREDGED (VIA SIDECASTING) TO FACILITATE ACCESS BY DEEPER DRAFT BARGES. STOCKPILES OF SIDECAST MATERIAL SHALL BE MARKED WITH TEMPORARY WARNING SIGNS AS SHOWN. UPON COMPLETION OF THE WORK, FLOTATION CHANNELS SHALL BE BACKFILLED WITH SIDECAST MATERIAL AND TEMPORARY WARNING SIGNS SHALL BE REMOVED. SEE SPECIFICATION TS-6 ACCESS AND FLOTATION CHANNELS FOR ADDITIONAL REQUIREMENTS.
- 11. CONTRACTOR SHALL TAKE PRECAUTIONS, SECURE EQUIPMENT, AND PROTECT THE WORK AGAINST ADVERSE WEATHER CONDITIONS REGARDLESS OF MARINE CONDITIONS.
- 12. REGULATORY AUTHORIZATIONS OBTAINED BY THE OWNER ARE INCLUDED IN APPENDIX G. ANY DISCREPANCIES BETWEEN THESE DOCUMENTS AND THE CONSTRUCTION DOCUMENTS SHALL BE IMMEDIATELY REPORTED TO THE ENGINEER. ALL OTHER REGULATORY AUTHORIZATIONS ARE THE RESPONSIBILITY OF THE CONTRACTOR.

#### SURVEY NOTES:

- ALL ELEVATIONS ARE REFERENCED TO THE NORTH AMERICAN VERTICAL DATUM OF 1988 (NAVD'88) IN U.S. SURVEY FEET (FEET) GEOID 99. ALL HORIZONTAL COORDINATES ARE REFERENCED TO THE NORTH AMERICAN DATUM OF 1983 (NAD'83), LOUISIANA STATE PLANE, SOUTH ZONE, IN FEET.
- TIDAL DATUMS IN THE TABLE ON THIS SHEET ARE SHOWN FOR INFORMATIONAL PURPOSES ONLY. THE DATUMS SHOWN REPRESENT CONDITIONS AT NEARBY TIDE STATIONS AND DO NOT NECESSARILY REPRESENT CONDITIONS AT THE PROJECT SITE.
- 3. MONUMENTS USED FOR SURVEY CONTROL ARE SHOWN ON SHEET 3. SURVEY CONTROL EMPLOYED DURING CONSTRUCTION SHALL MATCH SURVEY CONTROL PUBLISHED IN THESE CONTRACT DOCUMENTS. TO MAINTAIN CONSISTENCY BETWEEN PROJECT DESIGN AND CONSTRUCTED WORK, UPDATES, CORRECTIONS OR OTHER CHANGES PUBLISHED BY NATIONAL GEODETIC SURVEY AND/OR OTHER ENTITIES FOR THESE CONTROL MONUMENTS SHALL NOT BE APPLIED WITHOUT PRIOR WRITTEN CONCURRENCE BY ENGINEER.
- EXCEPT AS NOTED OTHERWISE, SPOT ELEVATIONS AND SURVEY TRANSECTS ARE BASED ON SURVEYS
  CONDUCTED BY JOHN CHANCE LAND SURVEYS, INC. DURING SEPTEMBER 2013 AND APRIL AND MAY 2014.


<b>ABBREVIATION</b>	ONS:
SWL	STILL WATER LEVEL
LWA	LIGHTWEIGHT AGGREGATE
HDG	HOT DIP GALVANIZED
GRR	GRADED RIPRAP
NIC	NOT IN CONTRACT
CCA	CHROMATED COPPER ARSENATE
N.T.S.	NOT TO SCALE
O.H.	OPPOSITE HAND
LDB	LIGHTED DAYBEACON
LEGEND:	
<u></u> ТВМ3	SURVEY CONTROL MONUMENT
$\odot$	EXISTING MAGNETOMETOR ANOMALY
	SETTLEMENT PLATE
$\Leftrightarrow$	HAZARD
•	APPROXIMATE LOCATION OF SOIL BORING/PROBE
- LDB ,	LIGHTED DAYBEACON
_0_	TEMPORARY WARNING SIGNS
+2. <sup>1</sup>	SPOT ELEVATION (FT.)
● <sup>B1</sup>	BREAKWATER ALIGNMENT POINT
	BREAKWATER FOOTPRINT
Dad	GRR ARMOR STONE
25 6 1 6 1 5 15 1 6 6	ENCAPSULATED LWA
	GRR BEDDING STONE
	TEMPORARY ACCESS/FLOTATION CHANNEL
	TEMPORARY STOCKPILE
	EXISTING OYSTER RING BREAKWATER (NIC)
	GEOTEXTILE COMPOSITE
	GEOTEXTILE SHROUD
470+00 480+00	CONSTRUCTION BASELINE
—— Р ——	EXISTING PIPELINE
-4	ELEVATION CONTOUR (FT.)

	SUMMARY OF ESTIMATED QUAN		100 105)
	BASE BID (BREAKWATER ALIGNMENT C1 - C25, B	1 - B11 AND A	<del>\33 - A25)</del>
ITEM NO.	DESCRIPTION	UNIT	ESTIMATED QUANTITY
1.1	MOBILIZATION AND DEMOBILIZATION	LUMP SUM	1
1.2	TOPOGRAPHIC AND BATHYMETRIC SURVEYING	LUMP SUM	1
1.3	PRE-CONSTRUCTION HAZARD SURVEY	LUMP SUM	1
1.4	AERIAL PHOTOGRAPHY	LUMP SUM	1
1.5	GEOTEXTILE COMPOSITE	LINEAR FEET	9,830
1.6	BEDDING LAYER STONE	TONS	18,700
1.7	ARMOR STONE	TONS	122,500
1.8	ENCAPSULATED LIGHTWEIGHT AGGREGATE	CU. YDS.	27,700
1.9	SETTLEMENT PLATES	EACH	11
1.10	LIGHTED DAYBEACONS	EACH	6
	ADDITIVE ALTERNATE NO. 1 BREAKWATER A	LIGNMENT A	25 - A13
ITEM NO.	DESCRIPTION	UNIT	ESTIMATED QUANTITY
2.1	ADDITIONAL MOBILIZATION AND DEMOBILIZATION	LUMP SUM	1
2.2	ADDITIONAL TOPOGRAPHIC AND BATHYMETRIC SURVEYING	LUMP SUM	1
2.3	ADDITIONAL PRE-CONSTRUCTION HAZARD SURVEY	LUMP SUM	1
2.4	ADDITIONAL AERIAL PHOTOGRAPHY	LUMP SUM	1
2.5	ADDITIONAL GEOTEXTILE COMPOSITE	LINEAR FEET	2,720
2.6	ADDITIONAL BEDDING LAYER STONE	TONS	5,300
2.7	ADDITIONAL ARMOR STONE	TONS	34,000
2.8	ADDITIONAL ENCAPSULATED LIGHTWEIGHT AGGREGATE	CU. YDS.	7,000
2.9	ADDITIONAL SETTLEMENT PLATES	EACH	3
2.10	ADDITIONAL LIGHTED DAYBEACONS	EACH	2
	ADDITIVE ALTERNATE NO. 2 BREAKWATER A	LIGNMENT A	13 - A2
ITEM NO.	DESCRIPTION	UNIT	ESTIMATED QUANTITY
3.1	ADDITIONAL MOBILIZATION AND DEMOBILIZATION	LUMP SUM	1
3.2	ADDITIONAL TOPOGRAPHIC AND BATHYMETRIC SURVEYING	LUMP SUM	1
3.3	ADDITIONAL PRE-CONSTRUCTION HAZARD SURVEY	LUMP SUM	1
3.4	ADDITIONAL AERIAL PHOTOGRAPHY	LUMP SUM	1
3.5	ADDITIONAL GEOTEXTILE COMPOSITE	LINEAR FEET	1,790
3.6	ADDITIONAL BEDDING LAYER STONE	TONS	3,400
3.7	ADDITIONAL ARMOR STONE	TONS	22,300
3.8	ADDITIONAL ENCAPSULATED LIGHTWEIGHT AGGREGATE	CU. YDS.	3,200
3.9	ADDITIONAL SETTLEMENT PLATES	EACH	2
3.10	ADDITIONAL LIGHTED DAYBEACONS	EACH	1
	ADDITIVE ALTERNATE NO. 3 BREAKWATER	ALIGNMENT	A2 - A1
ITEM NO.	DESCRIPTION	UNIT	ESTIMATED QUANTITY
4.1	ADDITIONAL MOBILIZATION AND DEMOBILIZATION	LUMP SUM	1
4.2	ADDITIONAL TOPOGRAPHIC AND BATHYMETRIC SURVEYING	LUMP SUM	1
4.3	ADDITIONAL PRE-CONSTRUCTION HAZARD SURVEY	LUMP SUM	1
4.4	ADDITIONAL AERIAL PHOTOGRAPHY	LUMP SUM	1
4.5	ADDITIONAL GEOTEXTILE COMPOSITE	LINEAR FEET	350
4.6	ADDITIONAL BEDDING LAYER STONE	TONS	850
4.7	ADDITIONAL ARMOR STONE	TONS	5,600

SUMMARY OF ESTIMATED QUANTITIES

	TIDAL DATU	IMS
	ELEVATION REFERE	NCED TO NAVD 88, FT
DATUM	GRAND ISLE, LOUISIANA NOAA STATION 8761724	SABINE PASS NORTH, TEXAS NOAA STATION 8770570
MHHW	+0.98	+1.23
MHW	+0.97	+1.13
MTL	+0.45	+0.58
MSL	+0.46	+0.59
MLW	-0.07	+0.04
MLLW	-0.08	-0.37
MINIMUM RECORDED WATER LEVEL	-3.15 (01/13/64)	-4.12 (01/19/96)

ADDITIONAL ENCAPSULATED LIGHTWEIGHT AGGREGATE

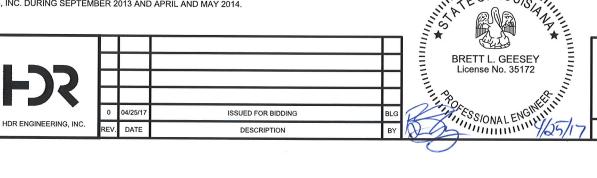

COASTAL PROTECTION & RESTORATION AUTHORITY ENGINEERING DIVISION

DRAWN BY: E. CONTRERAS

150 TERRACE AVENUE BATON ROUGE, LOUISIANA 70802

DESIGNED BY: ERIN ROONEY, P.E.


ROCKEFELLER REFUGE GULF SHORELINE STABILIZATION PROJECT	GENERAL NOTES
STATE PROJECT NUMBER: ME-18	
FEDERAL PROJECT NUMBER: ME-18	DATE: APRIL 2017
APPROVED BY: BRETT L. GEESEY, P.E.	SHEET 2 OF 23


1.100


CU. YDS.


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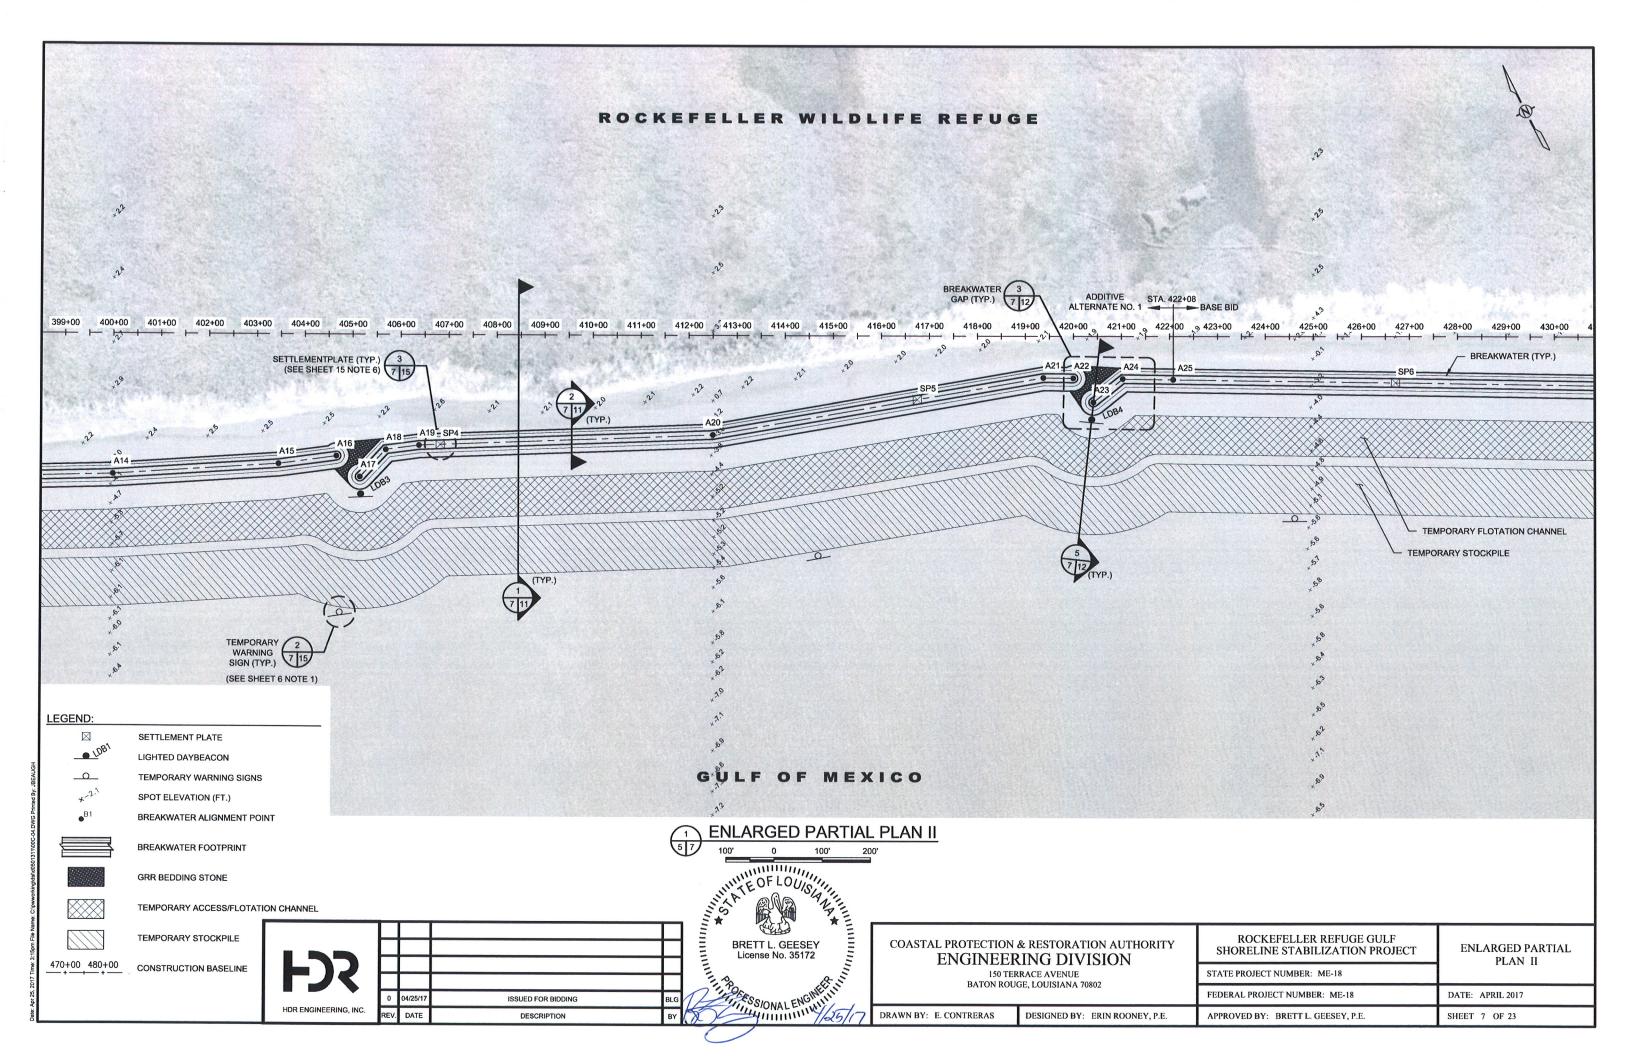
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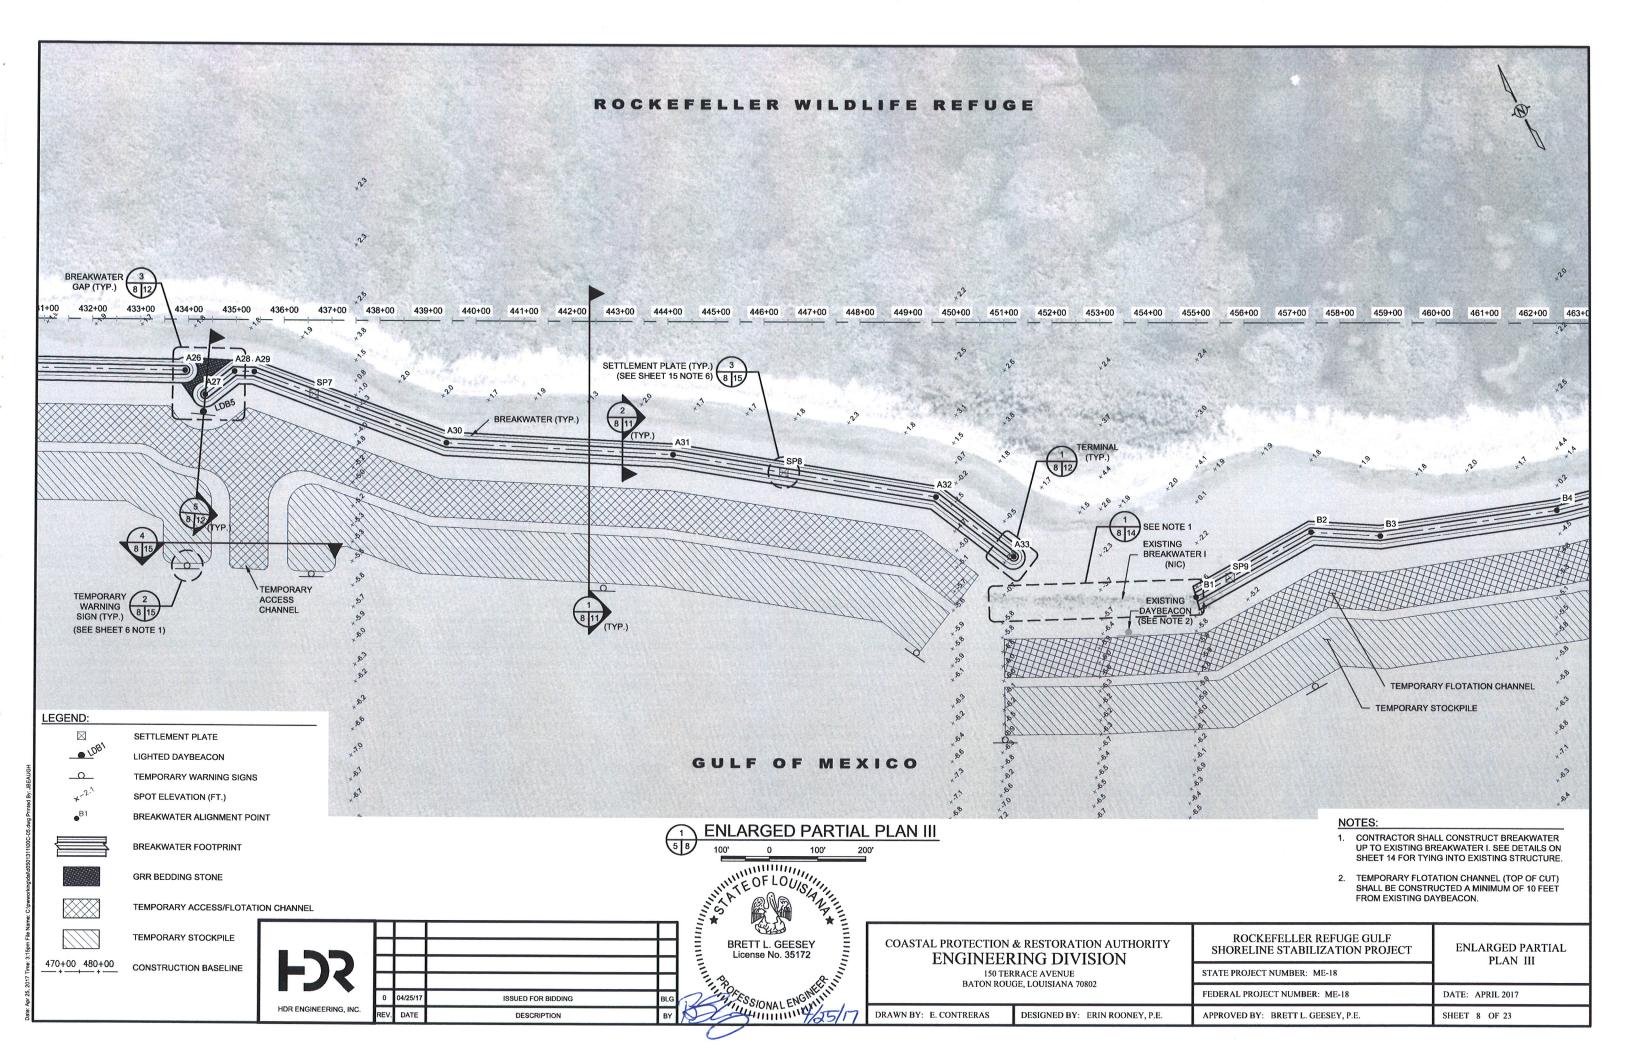





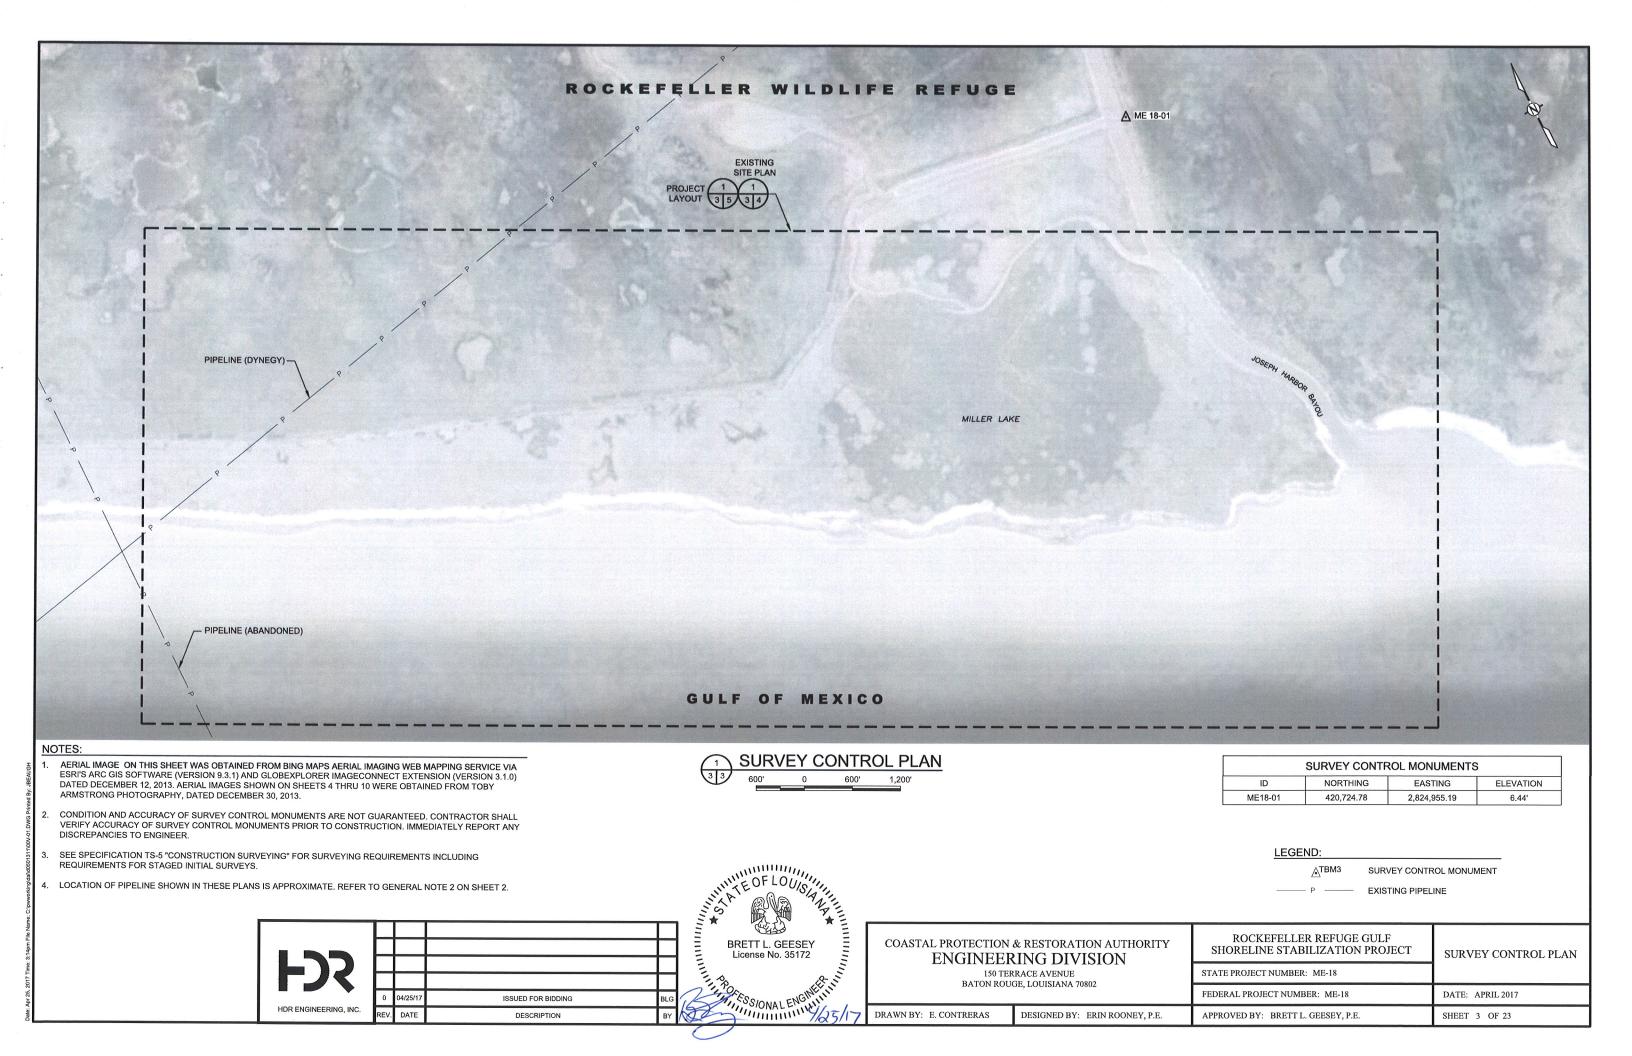


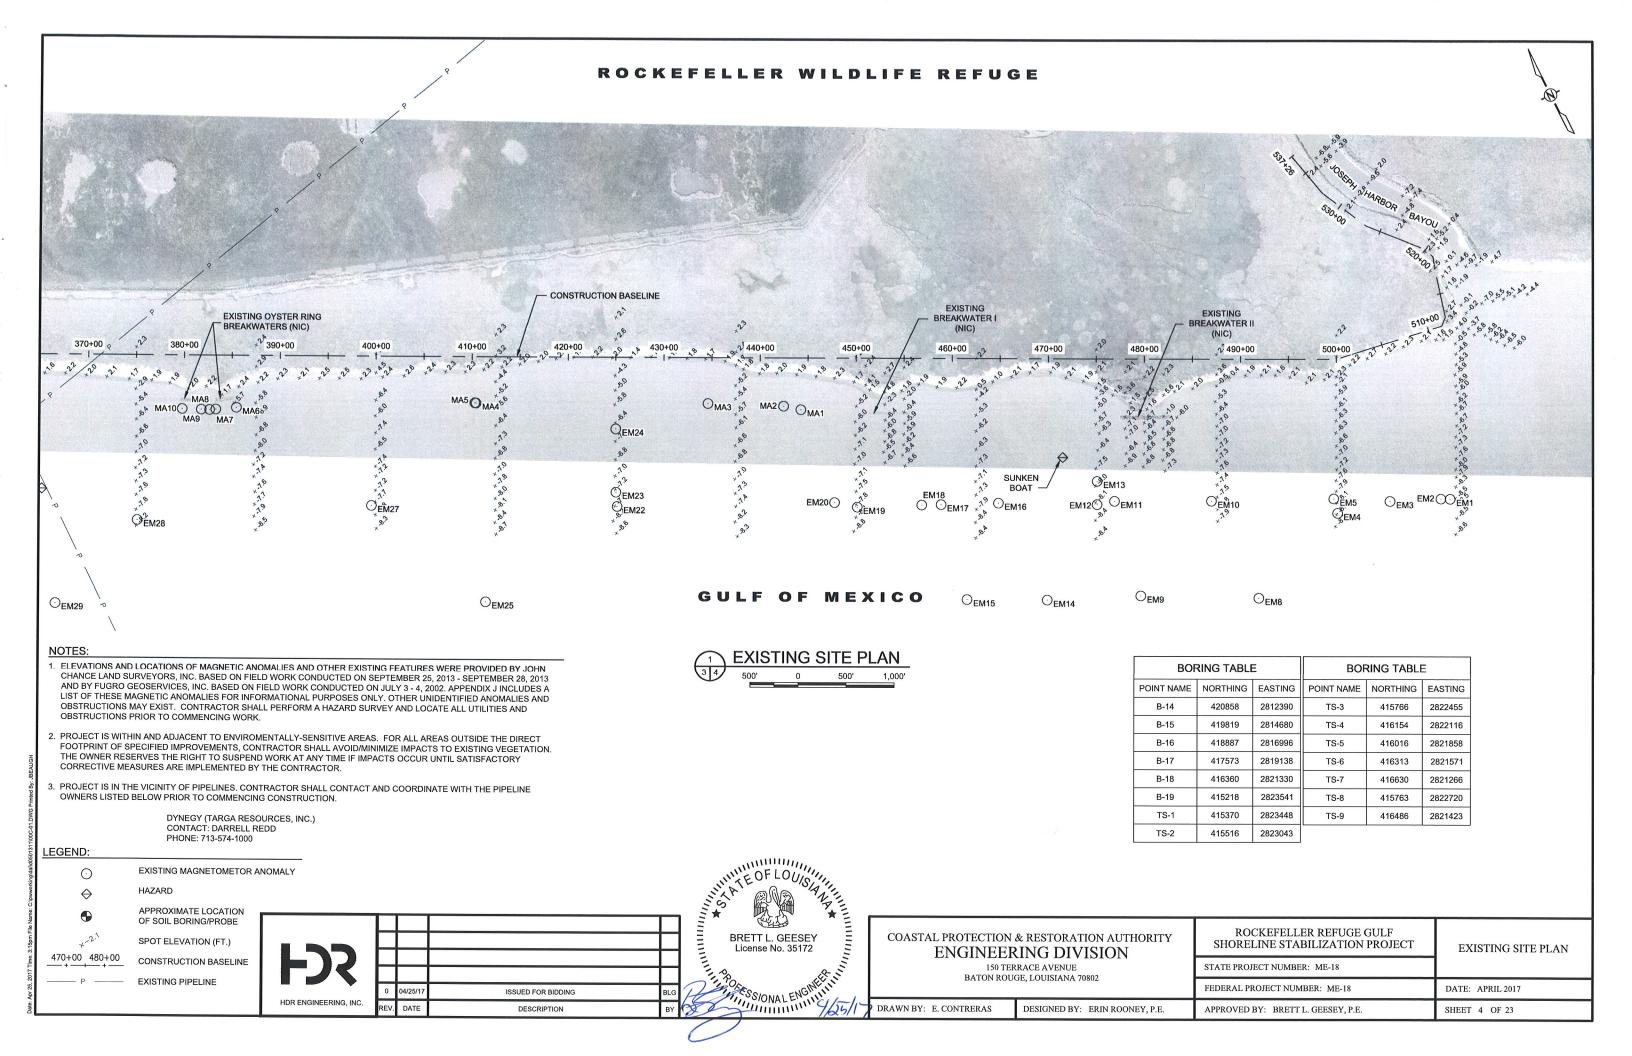


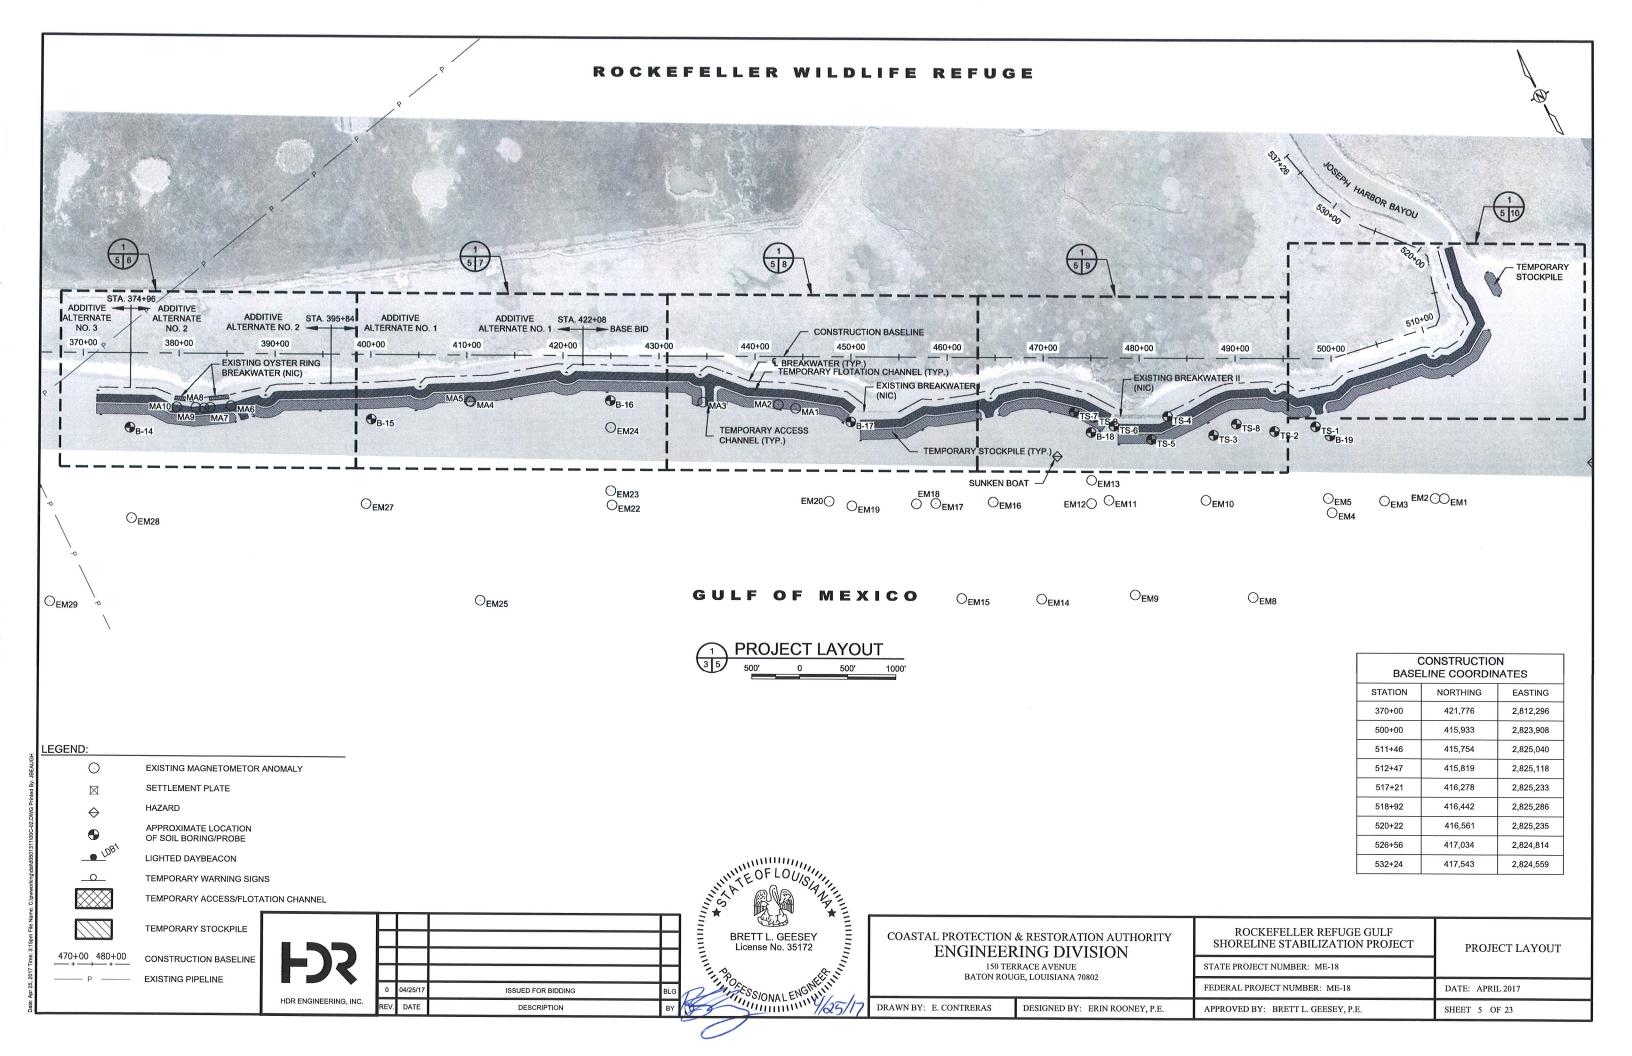


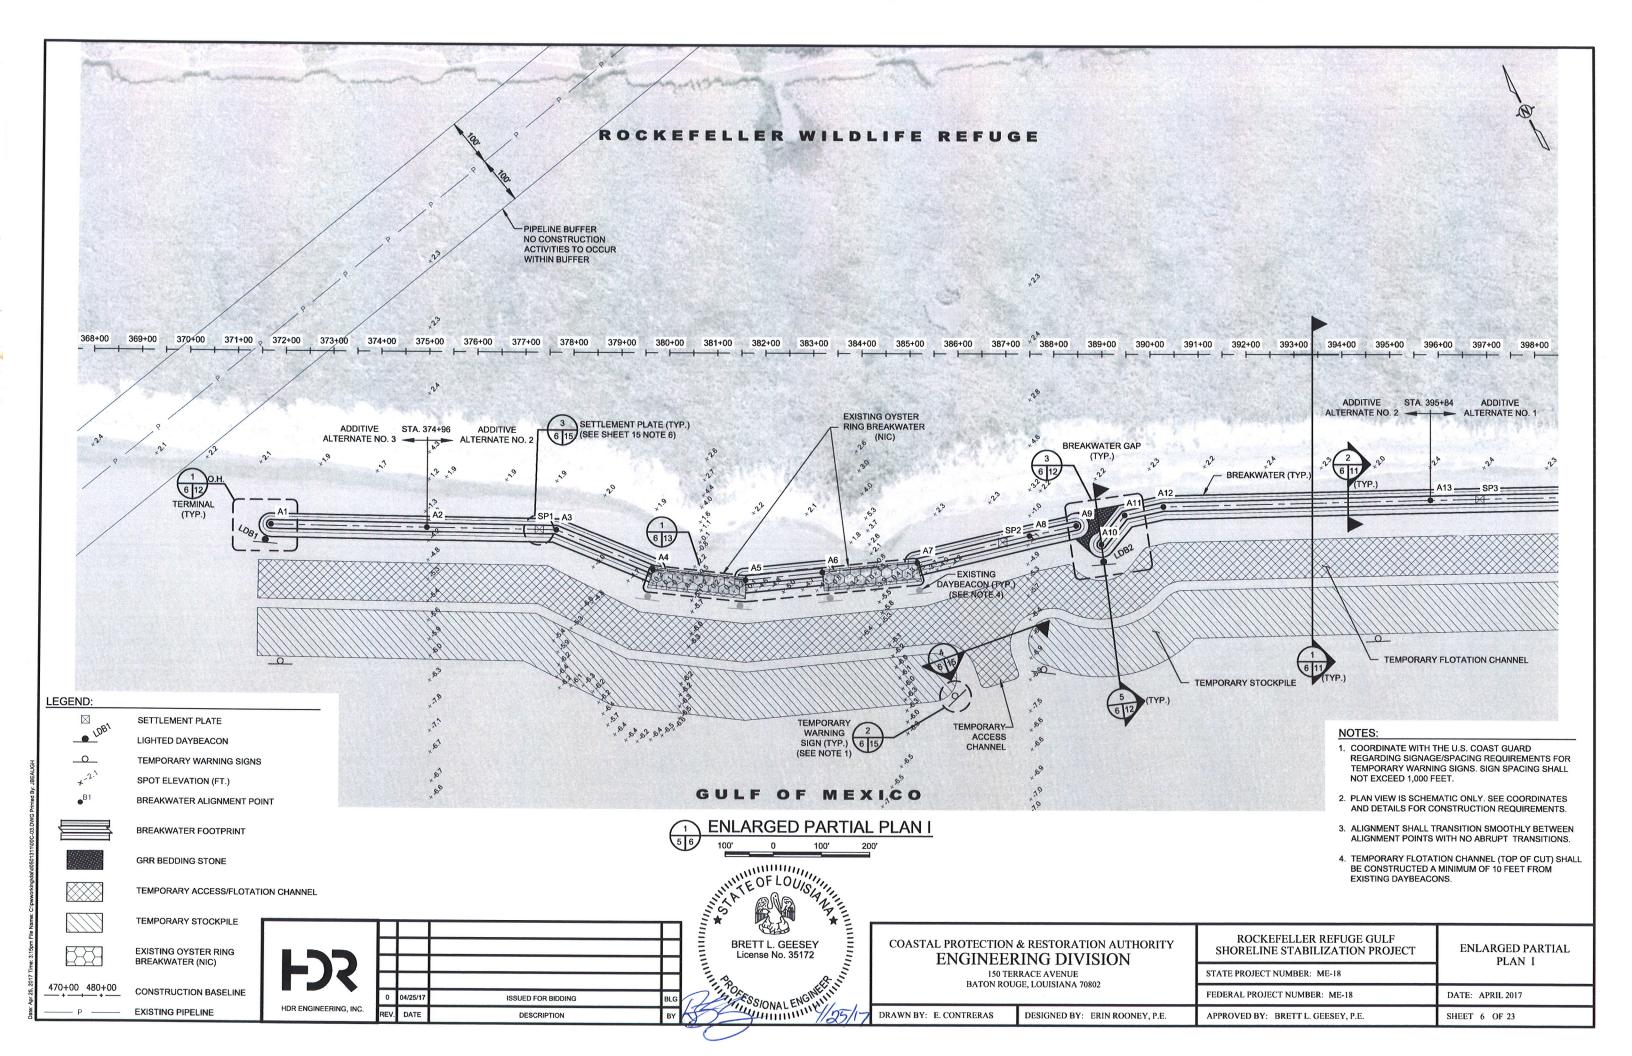


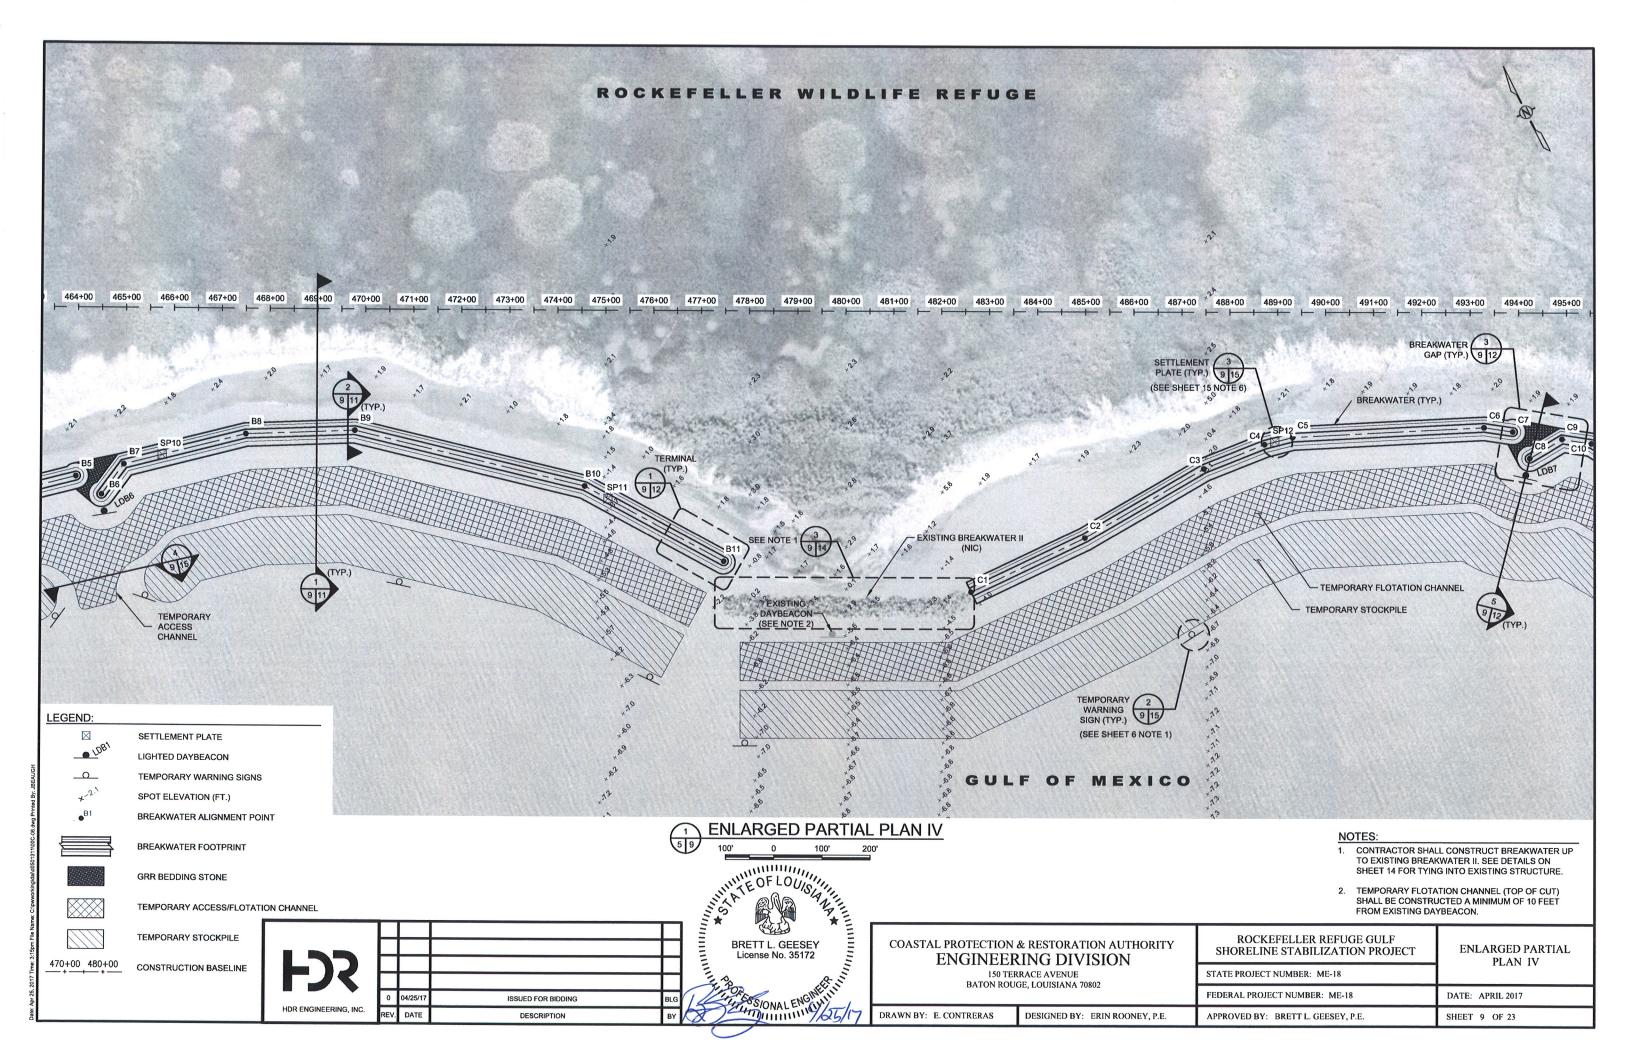


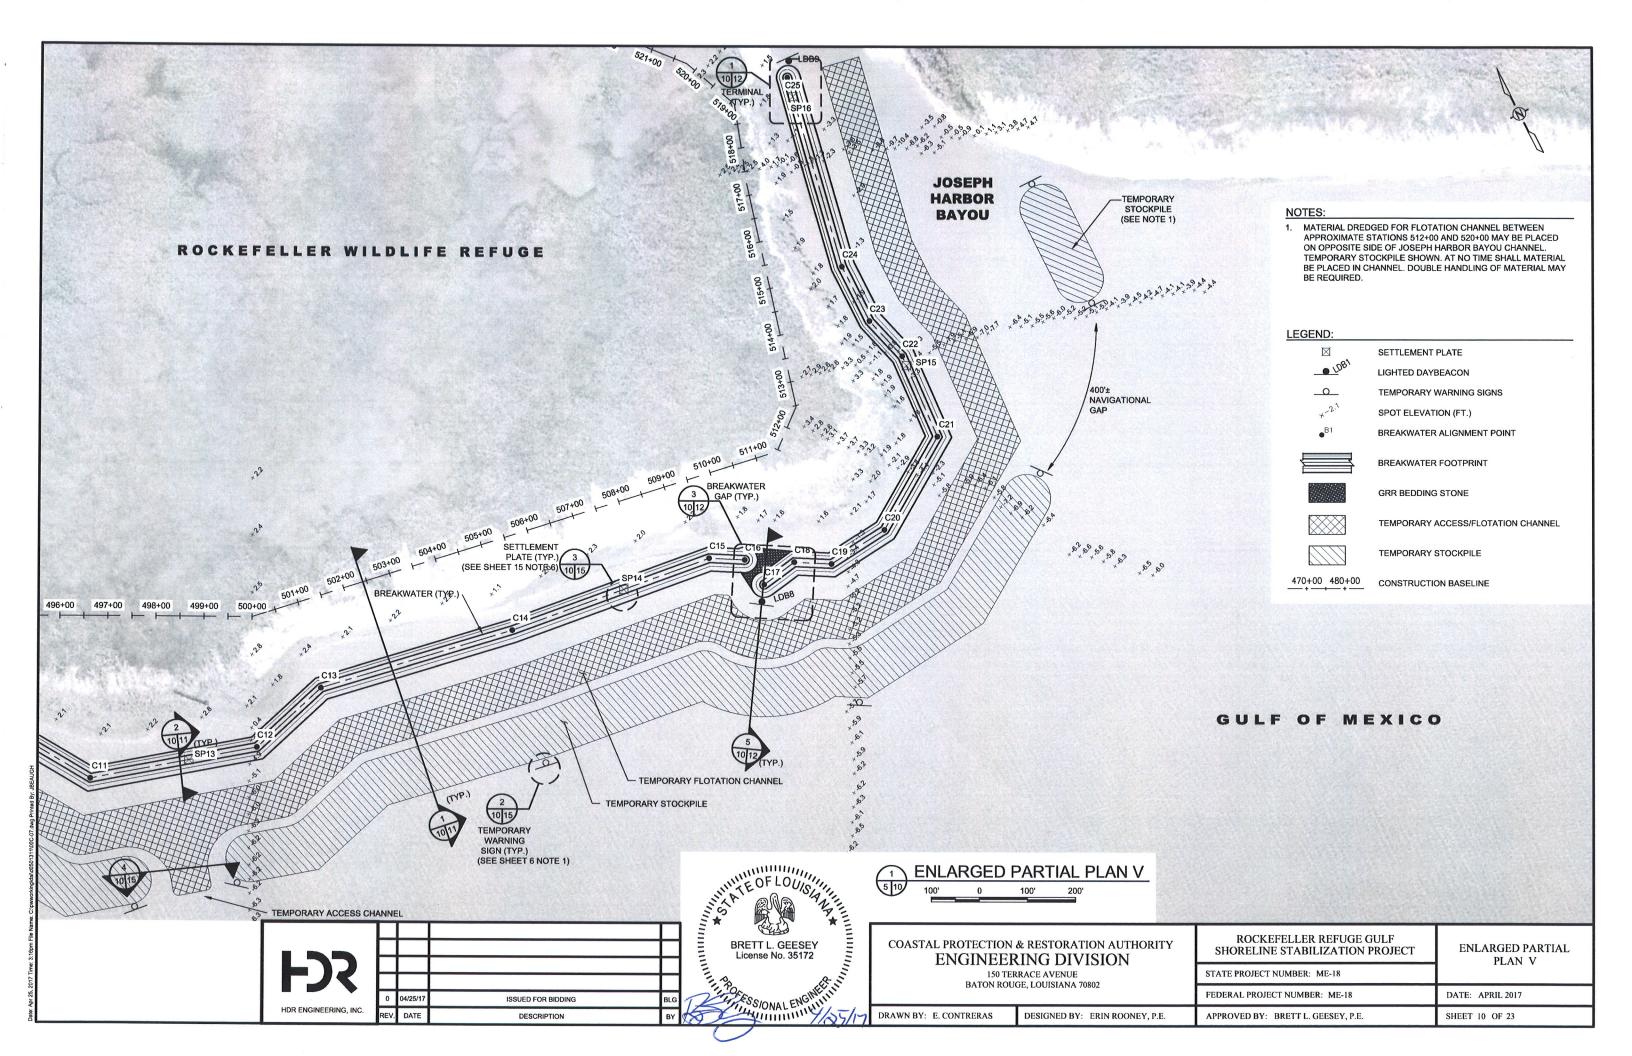

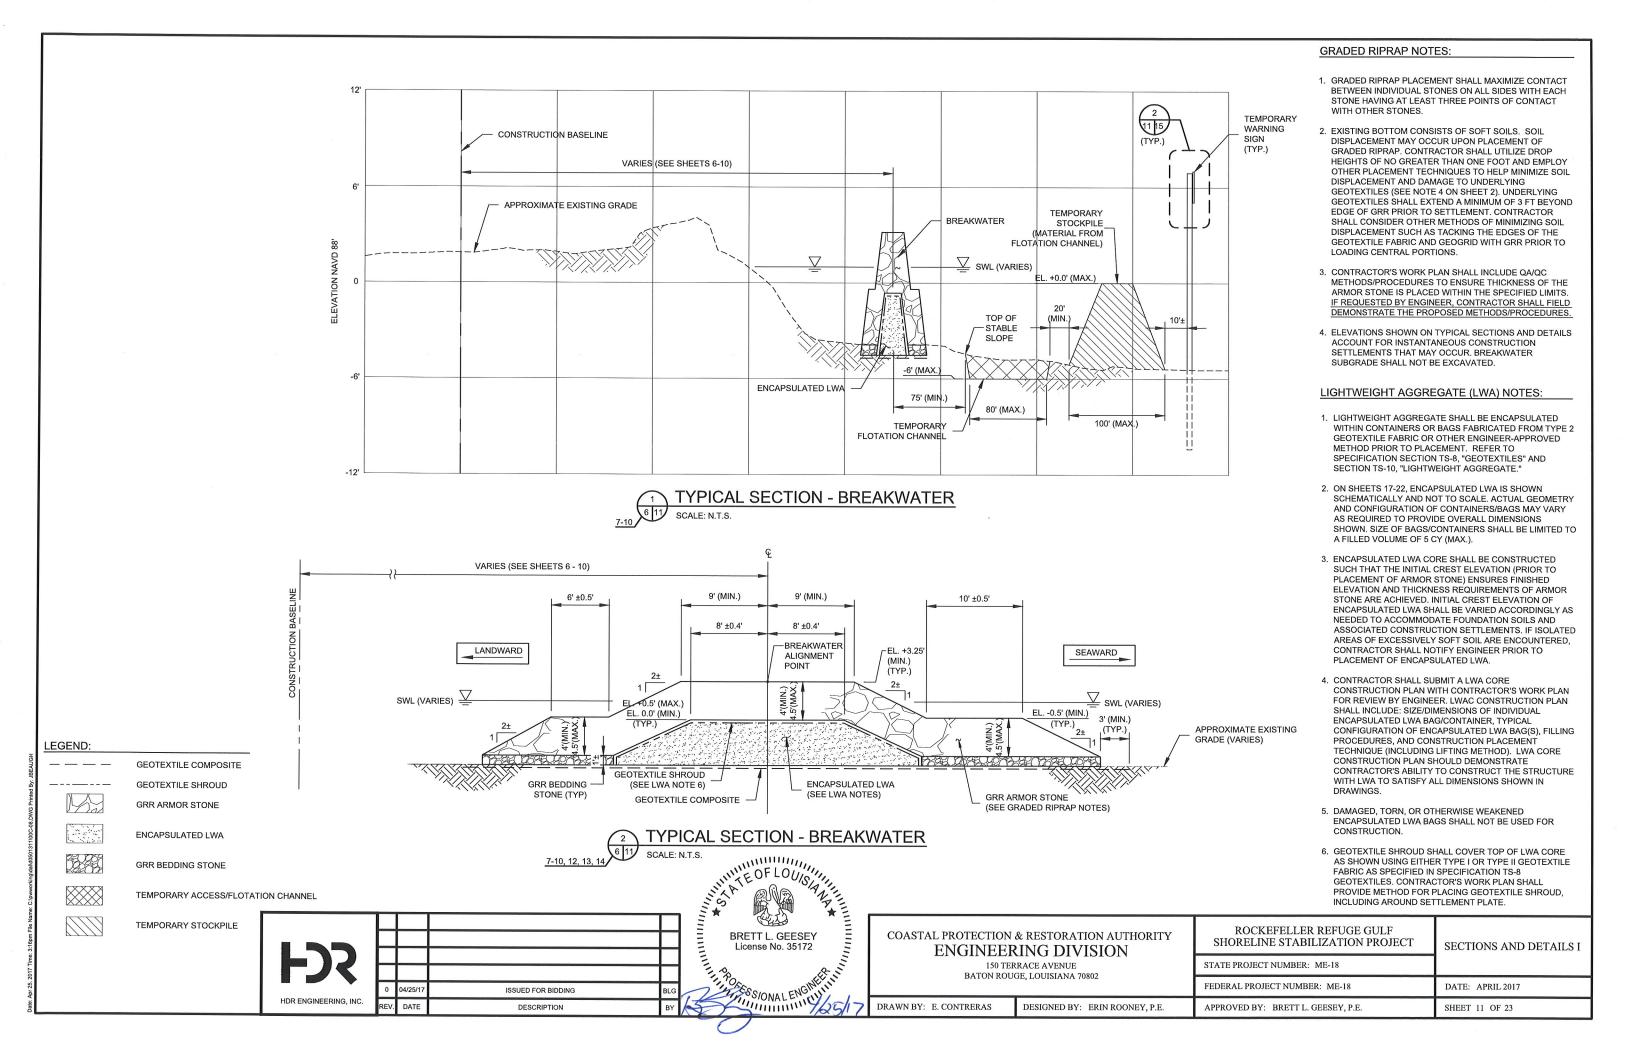

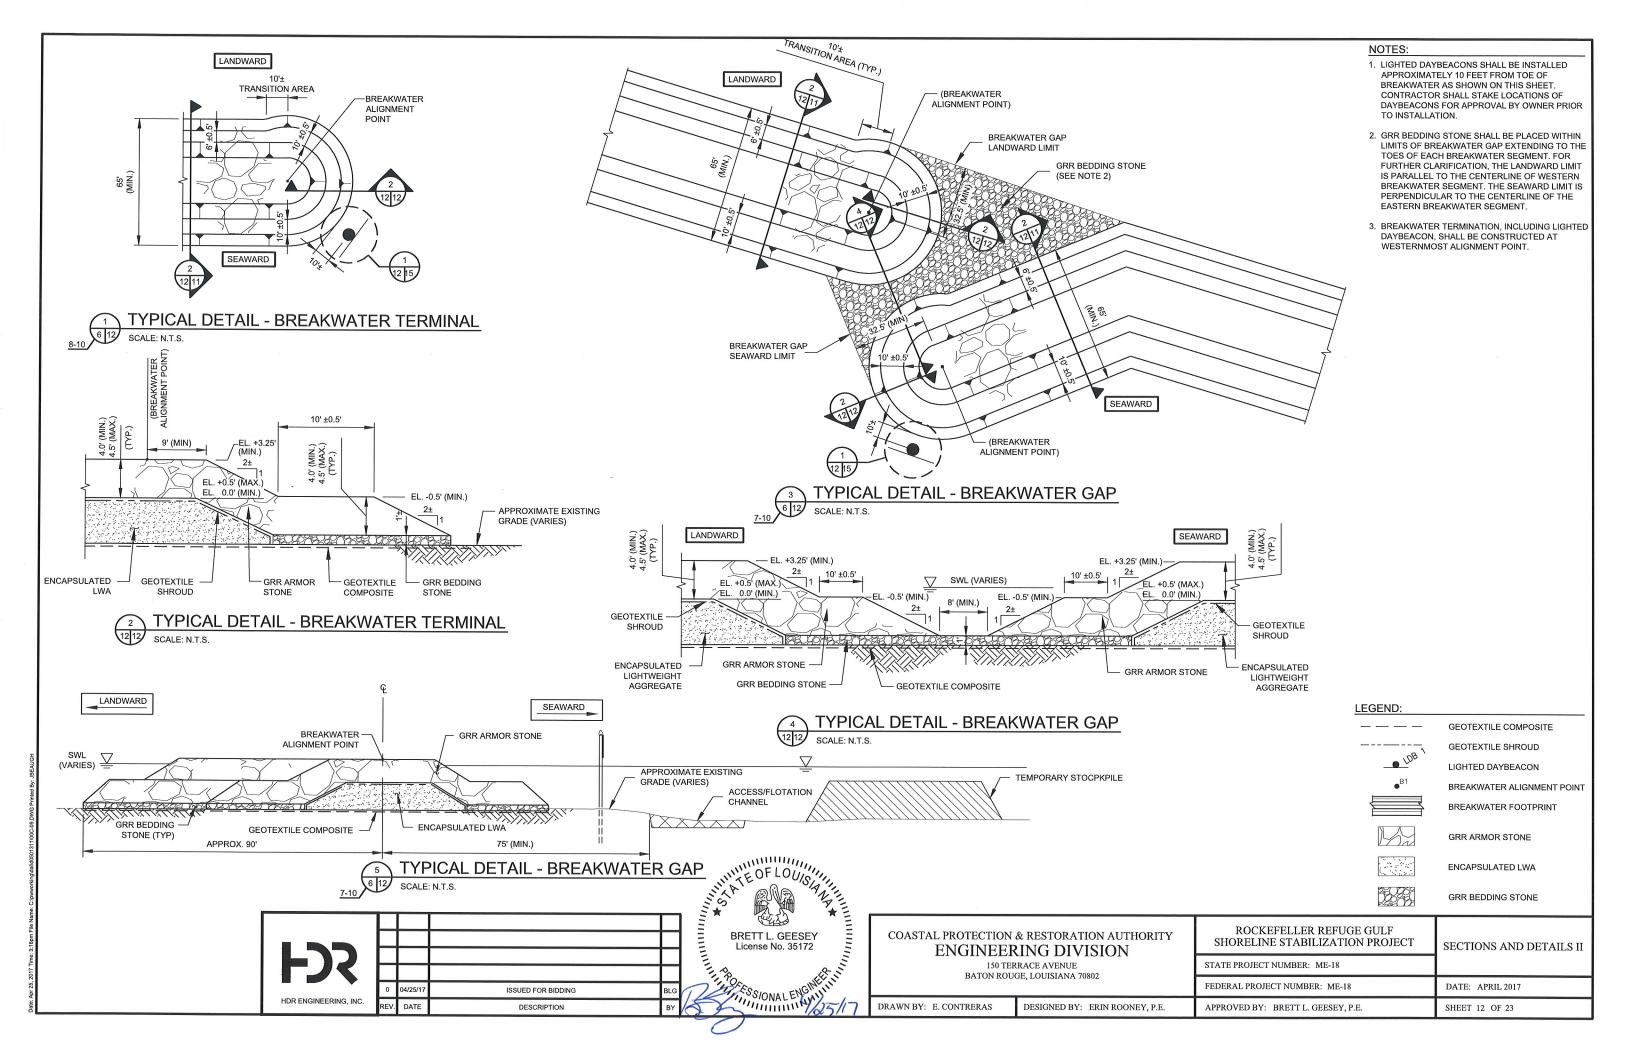

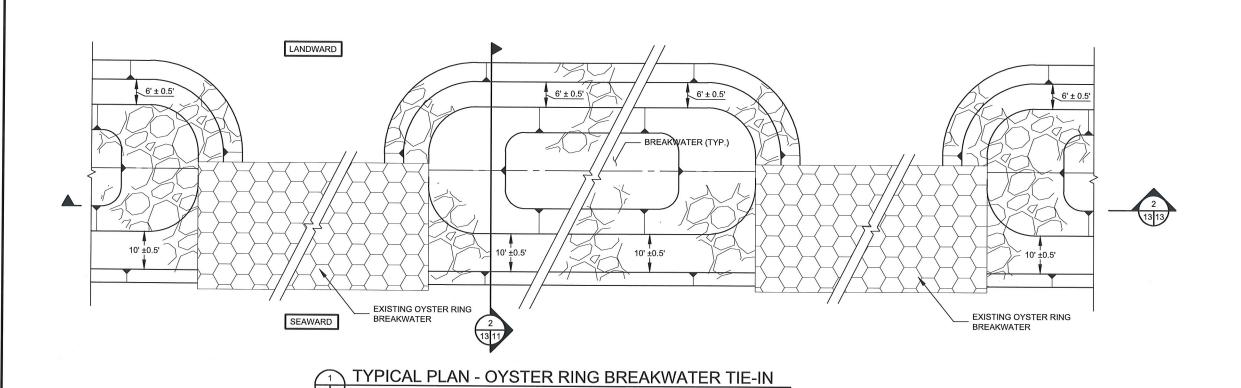

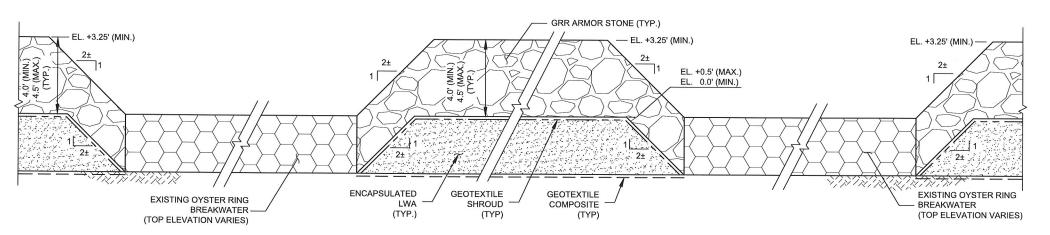

TYPICAL SECTION - OYSTER RING BREAKWATER TIE-IN SCALE: N.T.S.

BRETT L.
License No. .

130/888/ONAL ENGINEERIN ISSUED FOR BIDDING HDR ENGINEERING, INC. DESCRIPTION

## **ENGINEERING DIVISION**

BATON ROUGE, LOUISIANA 70802

DRAWN BY: E. CONTRERAS

ROCKEFELLER REFUGE GULF

SECTIONS AND DETAILS III

SHEET 13 OF 23

GEOTEXTILE COMPOSITE

BREAKWATER FOOTPRINT

GEOTEXTILE SHROUD

**GRR ARMOR STONE** 

**ENCAPSULATED LWA** 

EXISTING OYSTER RING BREAKWATER

COASTAL PROTECTION & RESTORATION AUTHORITY

150 TERRACE AVENUE

DESIGNED BY: ERIN ROONEY, P.E.

SHORELINE STABILIZATION PROJECT STATE PROJECT NUMBER: ME-18

LEGEND:


NOTES:


 SEAWARD TOE OF BREAKWATER SHALL BE
 APPROXIMATELY IN LINE WITH SEAWARD TOE OF EXISTING OYSTER RING BREAKWATERS. 2. IN AREAS WHERE BREAKWATER IS DESIGNED AT A HIGHER ELEVATION THAN THE EXISTING

OYSTER RING BREAKWATER, BREAKWATER WILL SLOPE DOWN AT A GRADE OF APPROXIMATELY 2H:1V TO MEET GRADE OF EXISTING OYSTER RING BREAKWATER.


3. CONTRACTOR SHALL MINIMIZE DISTURBANCE OF EXISTING OYSTER RING BREAKWATERS.

FEDERAL PROJECT NUMBER: ME-18 DATE: APRIL 2017 APPROVED BY: BRETT L. GEESEY, P.E.

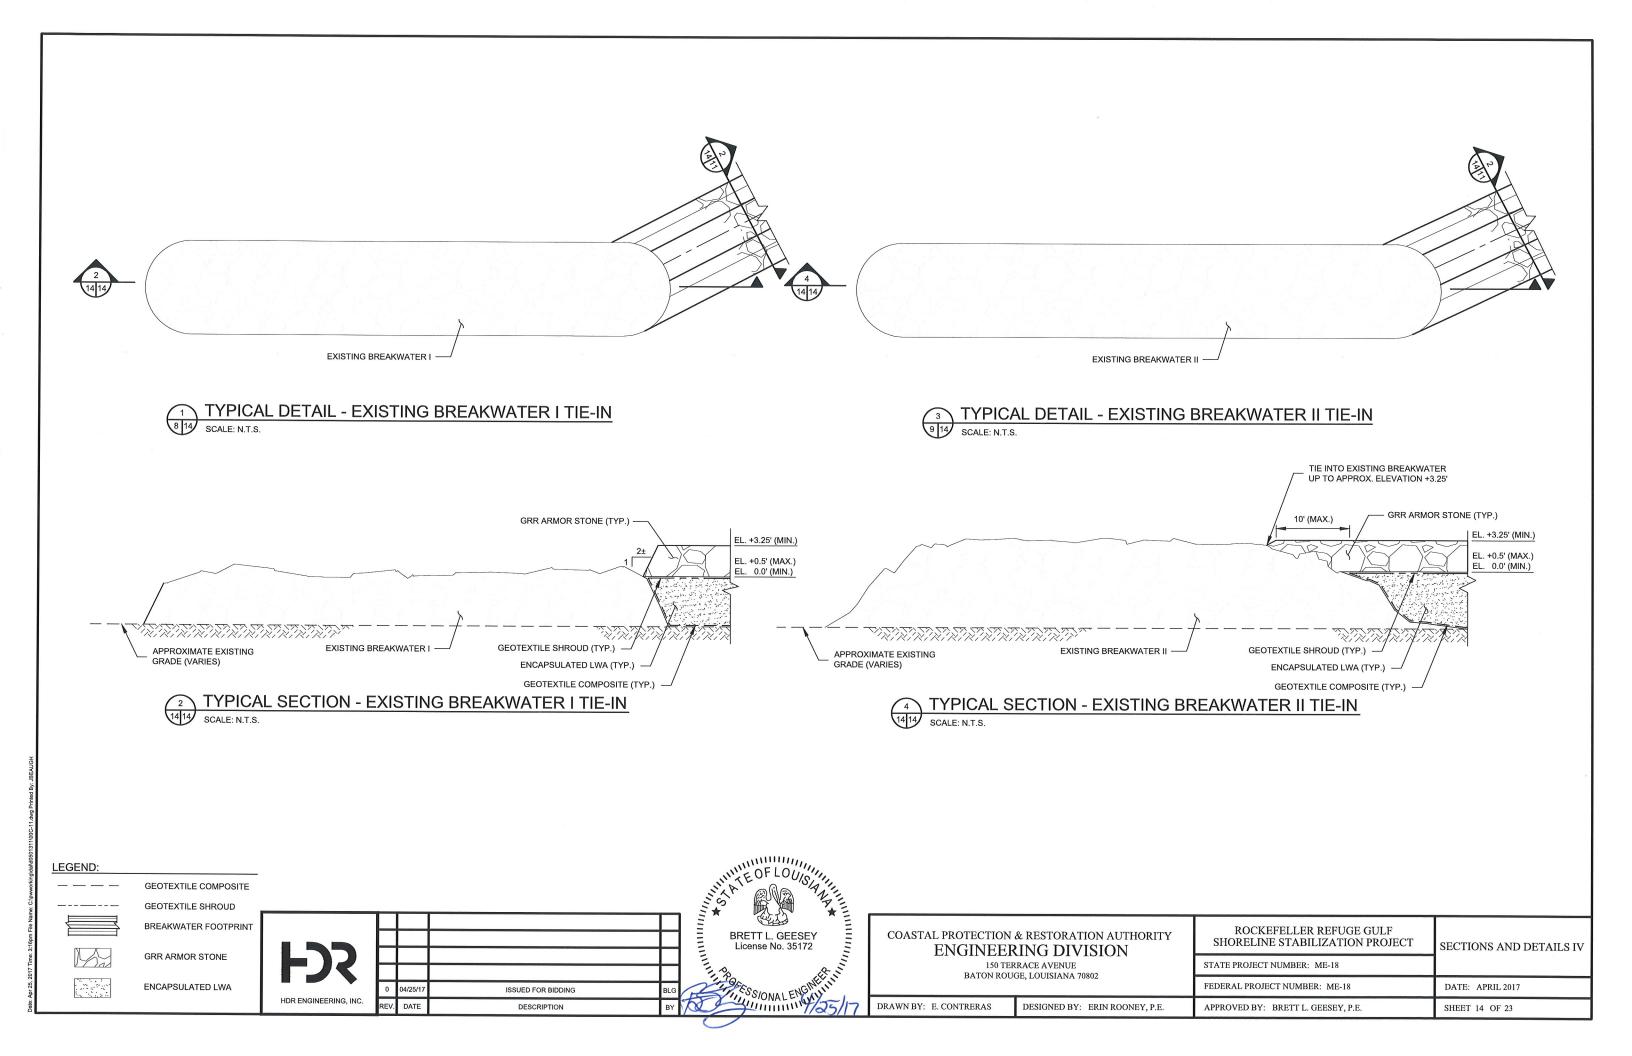


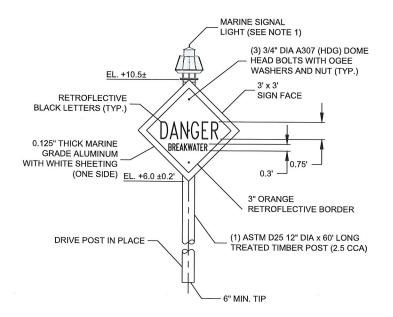




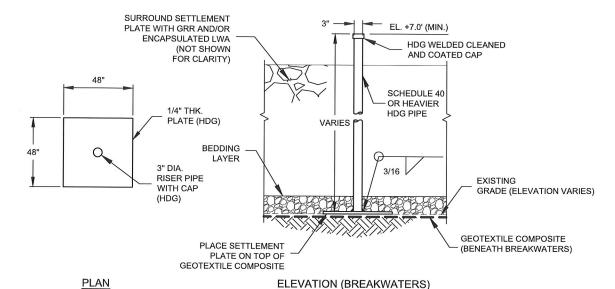

DETAIL - SETTLEMENT PLATES

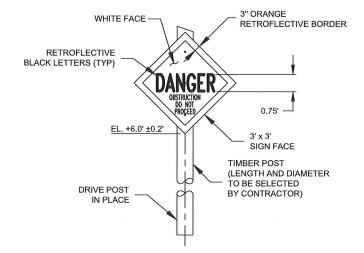

## **DETAIL-**TEMPORARY WARNING SIGN (SEE NOTE 2)

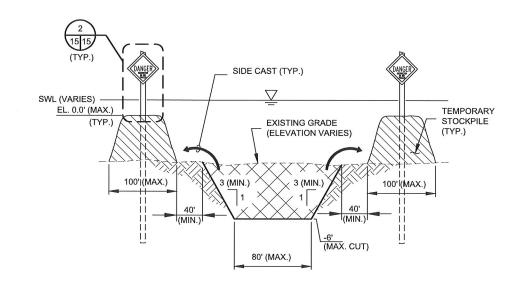

### TYPICAL SECTION - TEMPORARY ACCESS CHANNEL SCALE: N.T.S.

GEOTEXTILE COMPOSITE

LEGEND:

GRR BEDDING STONE

NOTES:

1. MARINE SIGNAL LIGHT SHALL MEET

ELECTRICAL RATING = 12V, 0.25A

FOLLOWING PROPERTIES:

PEDESTAL LENGTH: 2.0'± SOLAR MODULE: 10W

RANGE: 1 MILE

LENSE: CLEAR SLOW FLASH: 2.5 SEC

REQUIREMENTS OF 33 CFR FOR CLASS "C"

STRUCTURES AND HAVE, AS MINIMUM, THE

2. CONTRACTOR SHALL COORDINATE WITH U.S.

TEMPORARY WARNING SIGNS, INCLUDING

SIGN VERBAGE AND PLACEMENT LOCATION,

PRIOR TO INSTALLATION. CONTRACTOR MAY

NEED TO PHASE CONSTRUCTION ACTIVITIES

FOR TEMPORARY ACCESS AND FLOTATION

COAST GUARD ON REQUIREMENTS OF

CHANNELS TO SUIT MAXIMUM TIME REQUIREMENTS OF U.S. COAST GUARD

MARINE/NAVIGATION MARKERS. ANY

ENGINEER PRIOR TO INSTALLATION.

CHANGES SHALL BE COORDINATED WITH

3. OTHER FORMS OF TEMPORARY WARNING SIGNS MAY BE USED WITH PRIOR APPROVAL

OF U.S. COAST GUARD AND ENGINEER'S

4. CONTRACTOR SHALL BE RESPONSIBLE FOR

SIGNS UNTIL REMOVAL OF TEMPORARY

5. ALL SIGN FACES SHALL BE ORIENTED TO FACE PREDOMINANT APPROACH DIRECTION

6. SETTLEMENT PLATE LOCATIONS SHOWN ON SHEETS 6 TO 10 ARE SCHEMATIC. SETTLEMENT PLATES SHALL BE PLACED

CENTERLINE (CENTERLINE OF BREAKWATER

CREST). MAXIMUM SPACING OF SETTLEMENT

PLATES SHALL BE 1,000 FEET TO FACILITATE

CONTRACTOR SHALL PROVIDE SETTLEMENT

IN-PLACE MEASUREMENTS FOR PAYMENT

ALONG APPROXIMATE BREAKWATER

SUBSTANTIATION PURPOSES, TOTAL NUMBER OF SETTLEMENT PLATES SHALL BE

AS IDENTIFIED IN THE SUMMARY OF

ESTIMATED QUANTITIES ON SHEET 2.

PLATE COORDINATES TO ENGINEER A

MINIMUM OF 14 DAYS PRIOR TO INSTALLATION FOR APPROVAL

OF ONCOMING BOAT TRAFFIC.

STOCKPILES.

MAINTENANCE OF TEMPORARY WARNING


REGULATIONS FOR TEMPORARY



TEMPORARY ACCESS/FLOTATION CHANNEL



TEMPORARY STOCKPILE

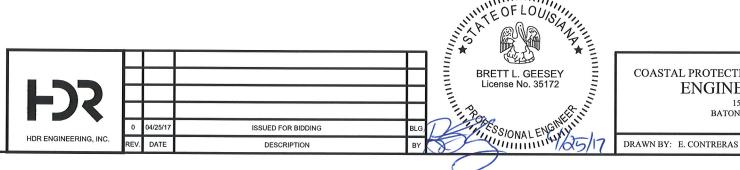

COASTAL PROTECTION & RESTORATION AUTHORITY **ENGINEERING DIVISION** 

150 TERRACE AVENUE

DESIGNED BY: ERIN ROONEY, P.E.

BATON ROUGE, LOUISIANA 70802

SHORELINE STABILIZATION PROJECT STATE PROJECT NUMBER: ME-18

ROCKEFELLER REFUGE GULF


MISCELLANEOUS DETAILS

FEDERAL PROJECT NUMBER: ME-18 DATE: APRIL 2017

APPROVED BY: BRETT L. GEESEY, P.E SHEET 15 OF 23

BREA	AKWATER ALI COORDINAT	
POINT	NORTHING	EASTING
A1	421377	2812286
A2	421226	2812575
А3	421103	2812813
A4	420938	2812956
A5	420833	2813119
A6	420776	2813269
A7	420706	2813454
A8	420651	2813689
A9	420627	2813785
A10	420568	2813814
A11	420601	2813885
A12	420581	2813965
A13	420344	2814468
A14	420166	2814844
A15	420032	2815163
A16	419992	2815278
A17	419931	2815302
A18	419958	2815376
A19	419935	2815442
A20	419681	2815999
A21	419480	2816668
A22	419451	2816723
A23	419387	2816738
A24	419403	2816815
A25	419355	2816907
A26	418808	2817960
A27	418744	2817975
A28	418760	2818051
A29	418741	2818088
A30	418430	2818380
A31	418198	2818792
A32	417874	2819242
A33	417690	2819331
B1	417445	2819632
B2	417459	2819907


BREA	AKWATER ALIO	
POINT	NORTHING	EASTING
В3	417387	2820032
B4	417271	2820384
B5	417238	2820532
В6	417181	2820563
В7	417216	2820633
B8	417160	2820889
В9	417065	2821096
B10	416749	2821472
B11	416479	2821662
C1	416192	2822093
C2	416187	2822356
C3	416205	2822642
C4	416193	2822778
C5	416181	2822837
C6	416021	2823202
C7	415986	2823251
C8	415922	2823257
C9	415927	2823335
C10	415891	2823387
C11	415781	2823458
C12	415685	2823797
C13	415737	2823972
C14	415667	2824381
C15	415618	2824815
C16	415582	2824880
C17	415518	2824893
C18	415531	2824970
C19	415494	2825037
C20	415508	2825167
C21	415632	2825353
C22	415815	2825363
C23	415911	2825335
C24	416038	2825334
C25	416441	2825410

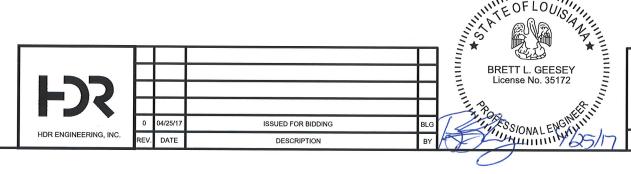

## COASTAL PROTECTION & RESTORATION AUTHORITY ENGINEERING DIVISION 150 TERRACE AVENUE BATON ROUGE, LOUISIANA 70802

DRAWN BY: E. CONTRERAS DESIGNED BY: ERIN ROONEY, P.E.

ROCKEFELLER REFUGE GULF SHORELINE STABILIZATION PROJECT	LOCATION POINT TABLES
STATE PROJECT NUMBER: ME-18	
FEDERAL PROJECT NUMBER: ME-18	DATE: APRIL 2017
APPROVED BY: BRETT L. GEESEY, P.E.	SHEET 16 OF 23

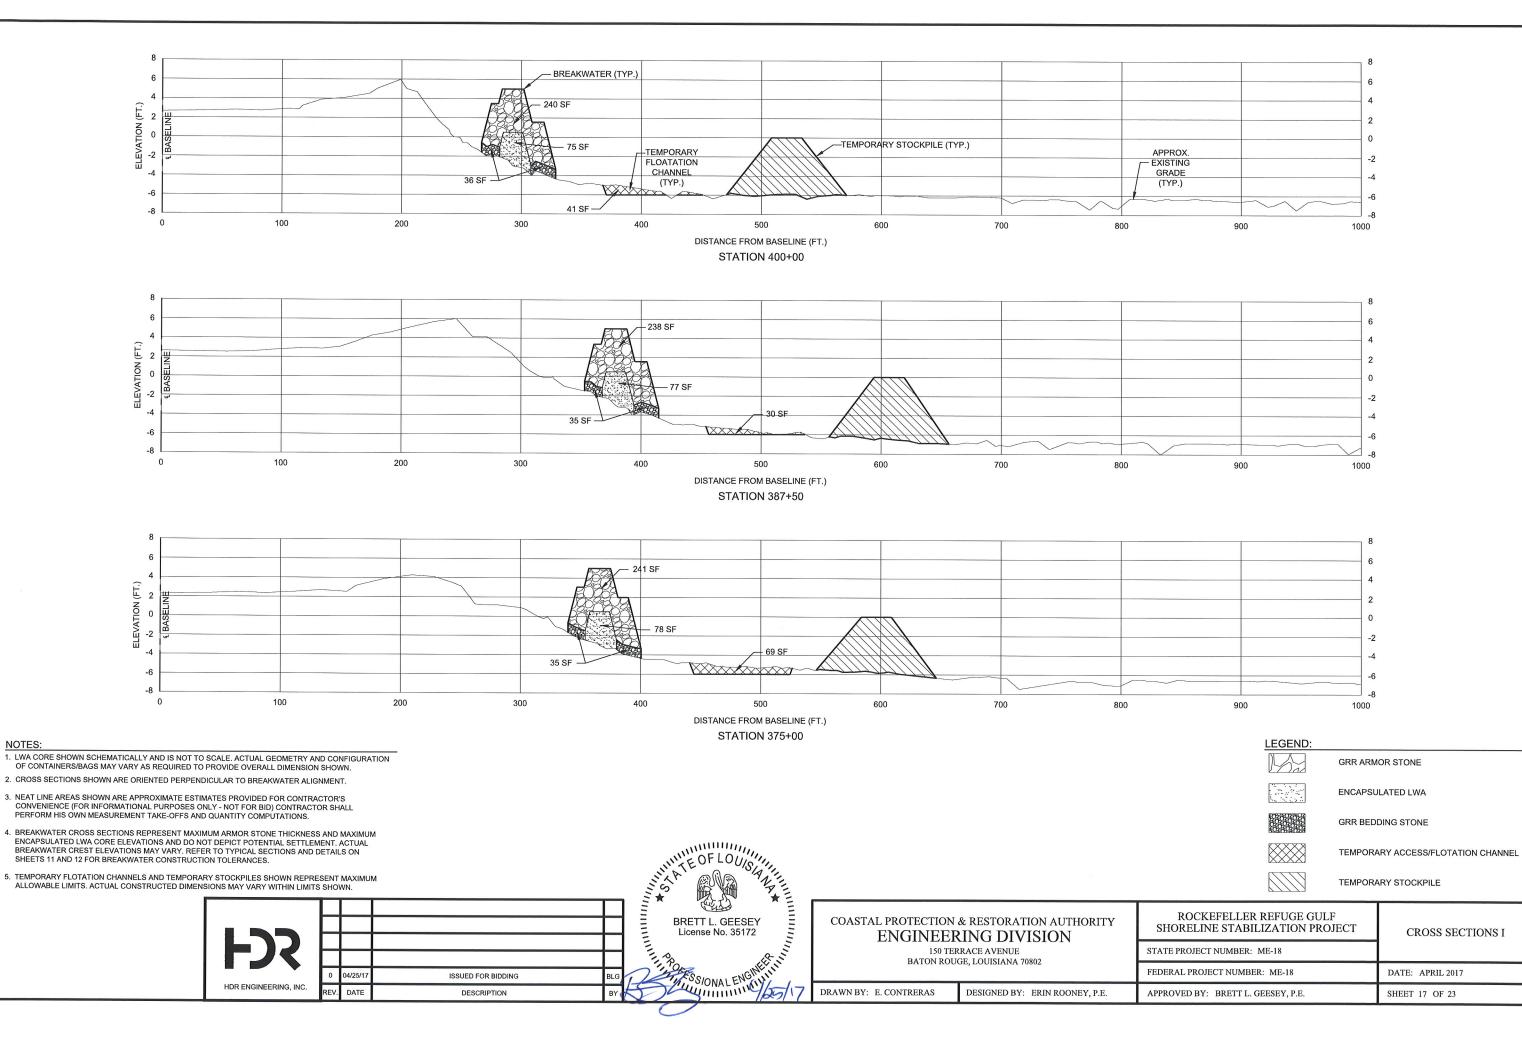

ISSUED FOR BIDDING

DESCRIPTION

HDR ENGINEERING, INC.

150 TERRACE AVENUE

BATON ROUGE, LOUISIANA 70802

DESIGNED BY: ERIN ROONEY, P.E.

DRAWN BY: E. CONTRERAS


STATE PROJECT NUMBER: ME-18


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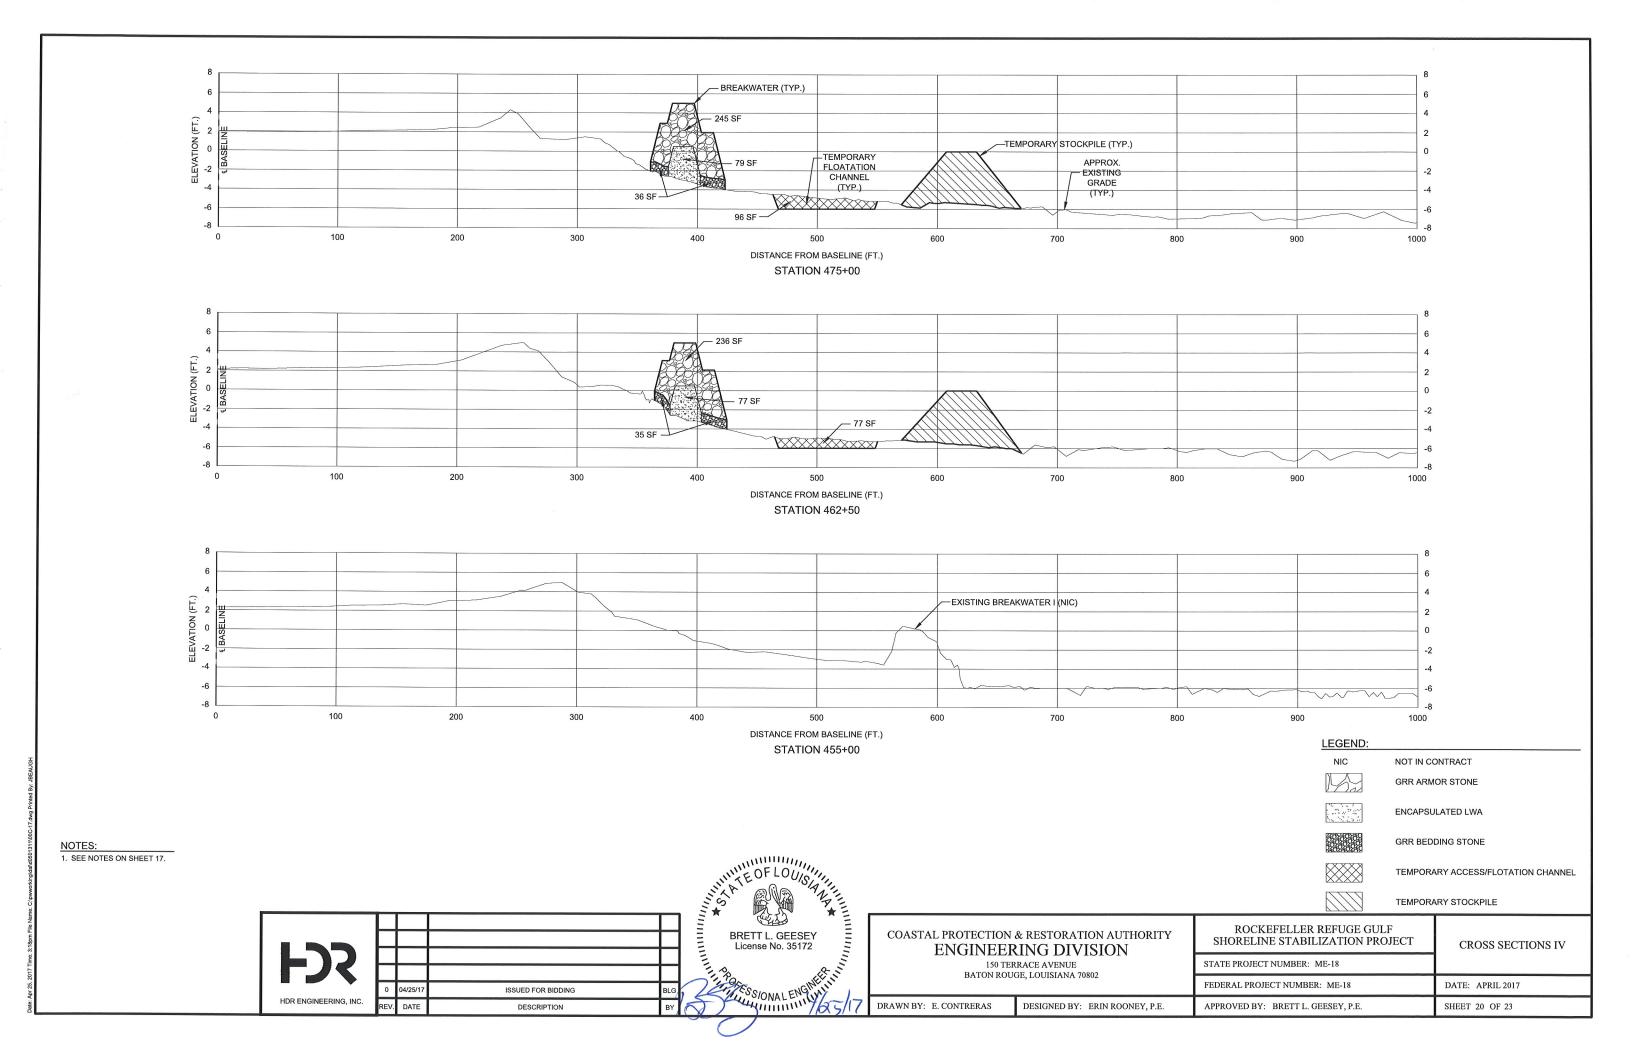
APPROVED BY: BRETT L. GEESEY, P.E.


DATE: APRIL 2017

SHEET 17 OF 23



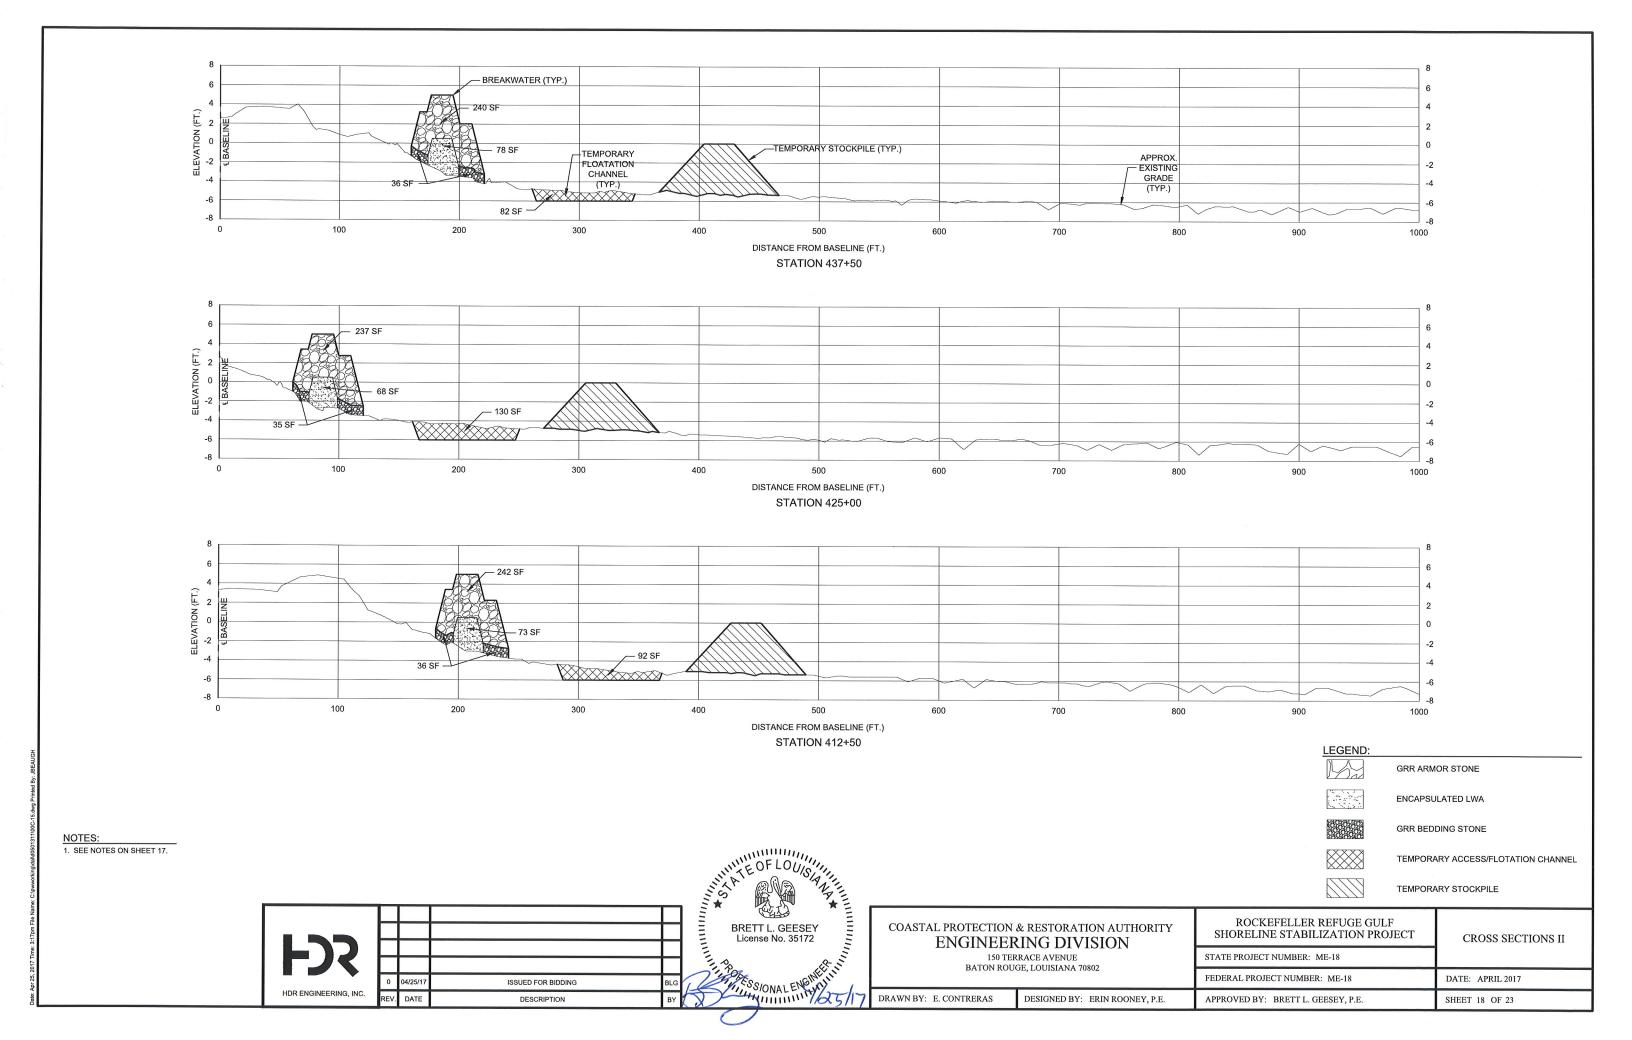

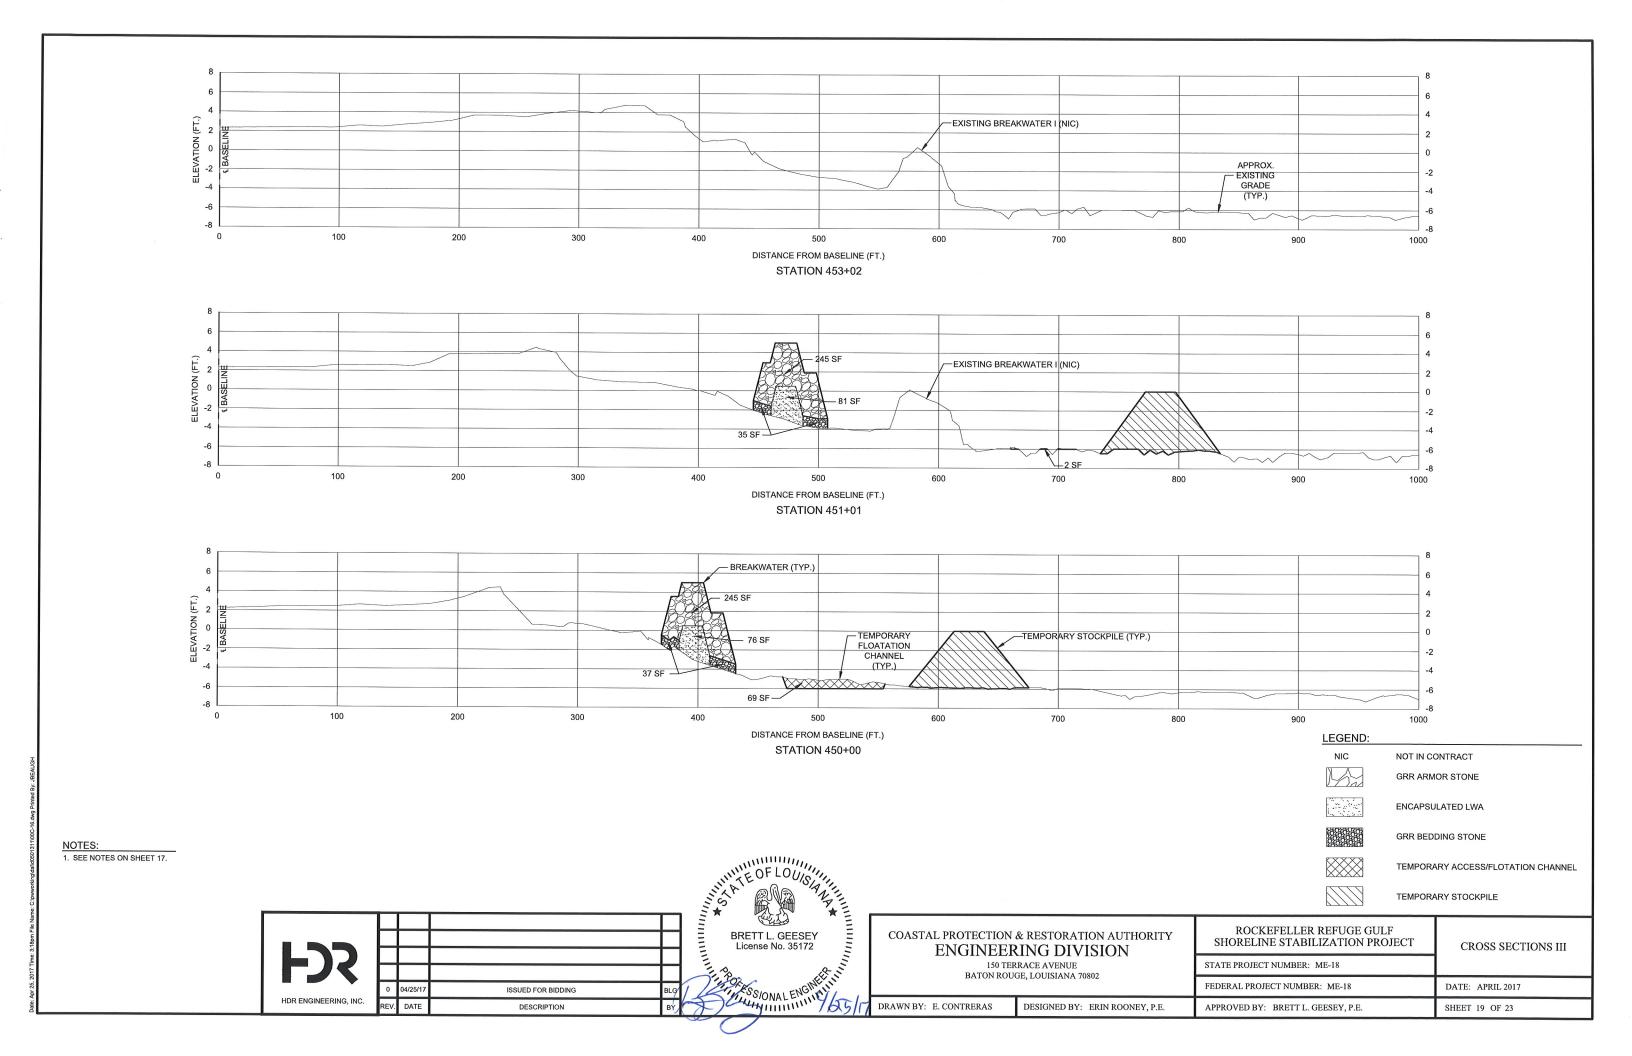

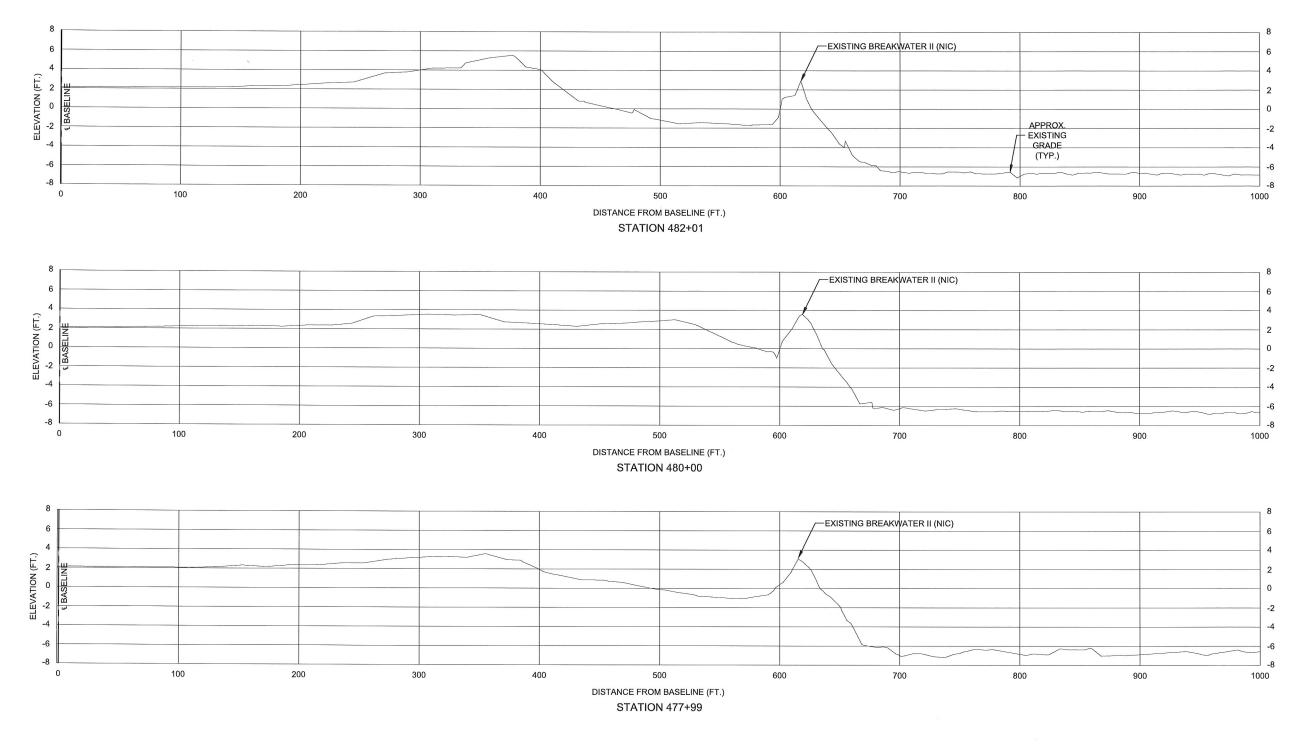


LEGEND:

NIC

NOT IN CONTRACT

NOTES: 1. SEE NOTES ON SHEET 17.

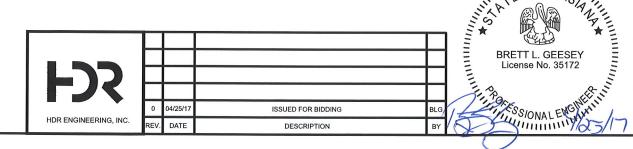

#### COASTAL PROTECTION & RESTORATION AUTHORITY **ENGINEERING DIVISION**

150 TERRACE AVENUE

DESIGNED BY: ERIN ROONEY, P.E.


ROCKEFELLER REFUGE GULF SHORELINE STABILIZATION PROJECT	
STATE PROJECT NUMBER: ME-18	


CROSS SECTIONS V


BATON ROUGE, LOUISIANA 70802

FEDERAL PROJECT NUMBER: ME-18 DATE: APRIL 2017 APPROVED BY: BRETT L. GEESEY, P.E. SHEET 21 OF 23

DRAWN BY: E. CONTRERAS

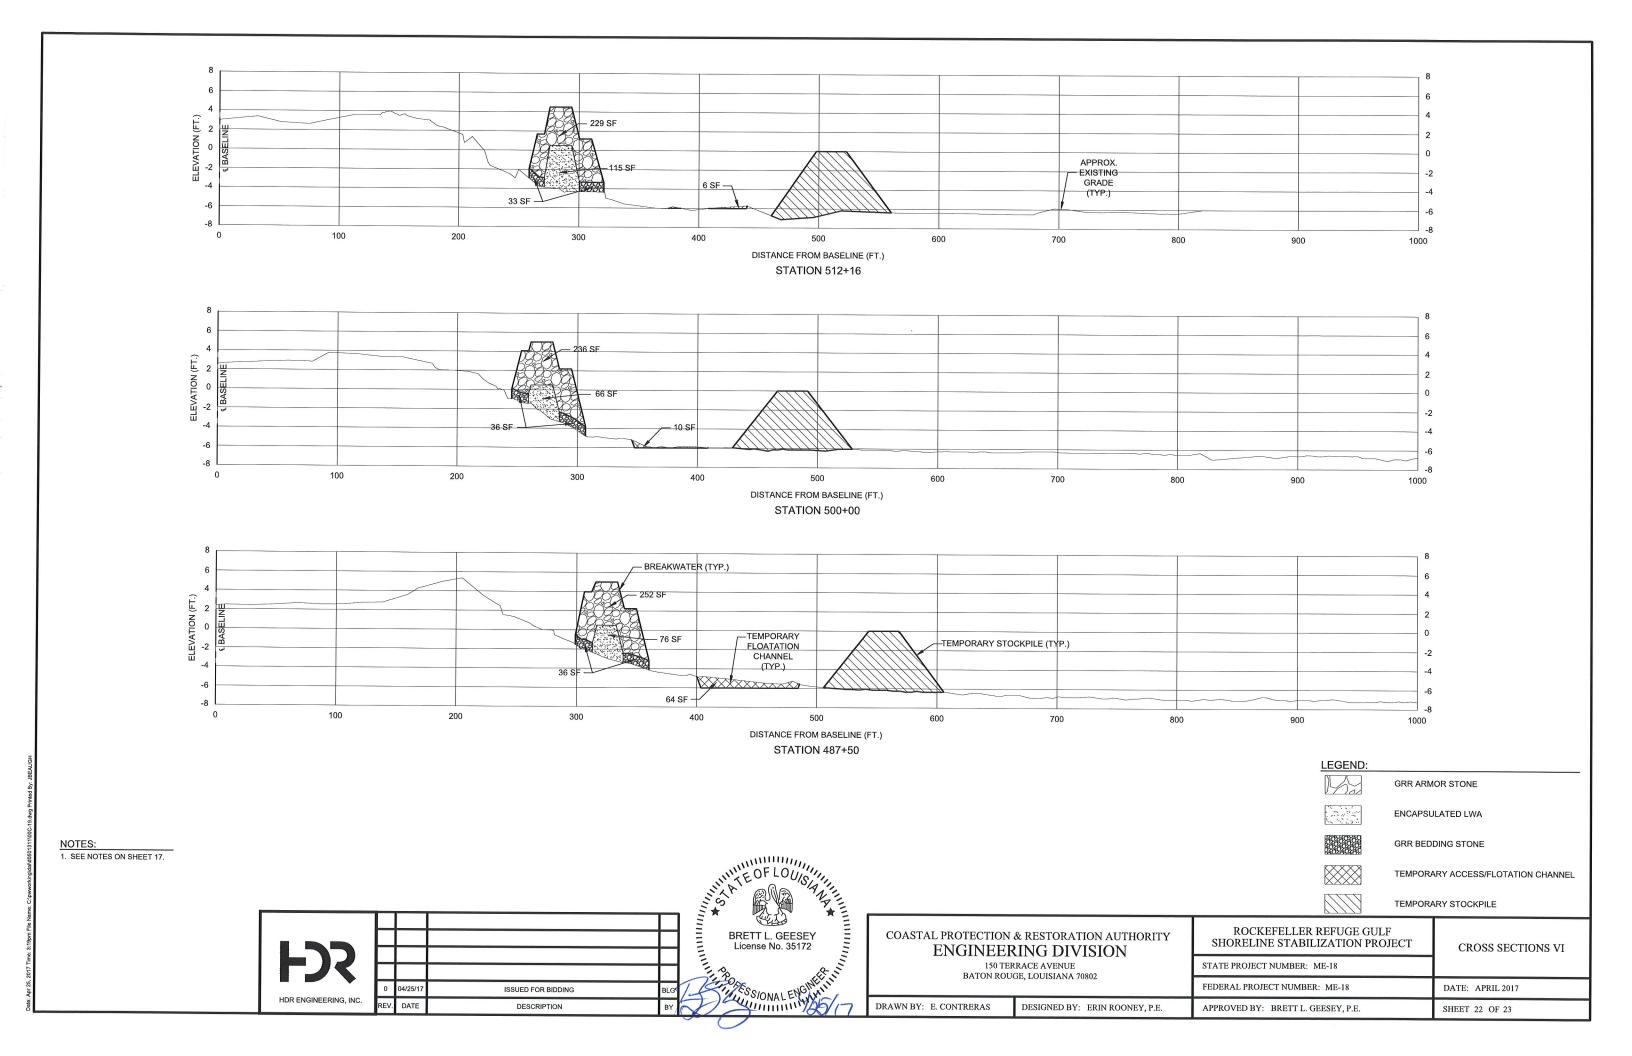

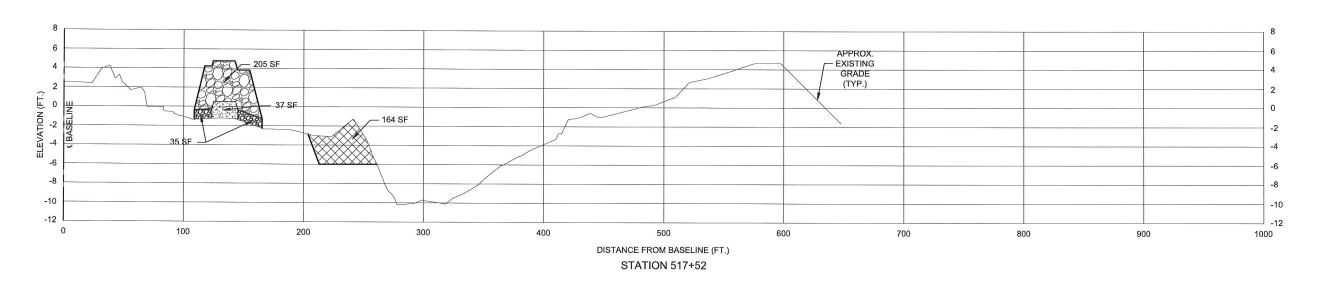

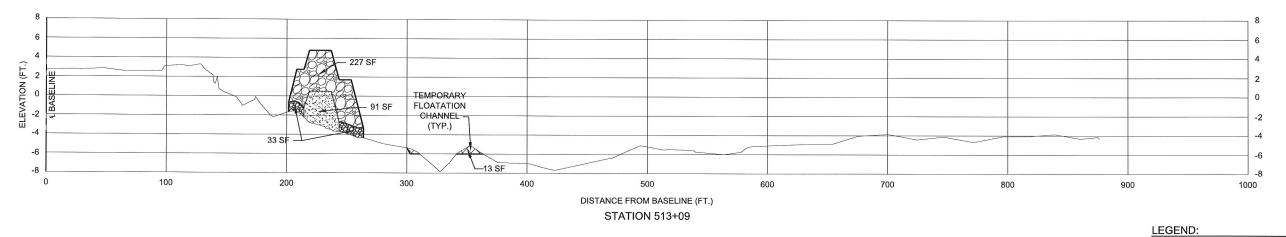

NOTES:

1. SEE NOTES ON SHEET 17.

BRETT L. GEESEY
License No. 35172

SS/ONAL ENGINEERING
HILLIAN
HILLIAN ISSUED FOR BIDDING HDR ENGINEERING, INC. DESCRIPTION

#### COASTAL PROTECTION & RESTORATION AUTHORITY **ENGINEERING DIVISION**

150 TERRACE AVENUE BATON ROUGE, LOUISIANA 70802

DRAWN BY: E. CONTRERAS DESIGNED BY: ERIN ROONEY, P.E.

SHORELINE STABILIZATION PROJECT
---------------------------------

CROSS SECTIONS VII

TEMPORARY ACCESS/FLOTATION CHANNEL

GRR ARMOR STONE

ENCAPSULATED LWA

GRR BEDDING STONE

TEMPORARY STOCKPILE

STATE PROJECT NUMBER: ME-18

FEDERAL PROJECT NUMBER: ME-18 DATE: APRIL 2017

APPROVED BY: BRETT L. GEESEY, P.E.

SHEET 23 OF 23